GENERAL NOTES

CONTRACT DOCUMENTS:
CONTRACT DOCUMENTS CONSIST OF THE AGREEMENT, GENERAL CONDITIONS, SPECIFICATIONS, DETAIL BOOK AND DRAWINGS, WHICH ARE COOPERATIVE AND CONTINUOUS. WORK INDICATED OR REASONABLY IMPLIED IN ANY ONE OF THE DOCUMENTS SHALL BE SUPPLIED AS THOUGH FULLY COVERED IN ALL. ANY DISCREPENCIES BETWEEN THE PARTS CHALL BE REPORTED TO THE ARCHITECT PRIOR TO THE COMMENCEMENT OF WORK. THESE DRAWINGS ARE PART OF THE CONTRACT DOCUMENTS FOR THIS PROJECT. THESE DRAWINGS ARE THE GRAPHIC ILLUSTRATION OF THE WORK TO BE ACCOMPLISHED. ALL DIMENSIONS NOTED TAKE PRECEDENCE OVER SCALED DIMENSIONS. DIMENSIONS NOTED WITH "N.T.S." DENOTES NOT TO SCALE.

THE DRAWINGS FOLLOW A LOGICAL, INTERDISCIPLINARY FORMAT: ARCHITECTURAL DRAWINGS (A SHEETS), CIVIL DRAWINGS (C SHEETS), STRUCTURAL (S SHEETS), MECHANICAL AND PLUMBING (M SHEETS), ELECTRICAL (E SHEETS) AND LIGHTING (LTG SHEETS).

CODE COMPLIANCE:
ALL WORK, MATERIALS, AND ASSEMBLIES SHALL COMPLY WITH APPLICABLE STATE AND LOCAL CODES, ORDINANCES, AND REGULATIONS. THE CONTRACTOR, SUBCONTRACTORS, AND JOURNEYMEN OF THE APPROPRIATE TRADES SHALL PERFORM WORK TO THE HIGHEST STANDARDS OF CRAFTSMANSHIP AND IN ACCORDANCE WITH AIA DOCUMENT A201-SECTION 3. THE BUILDING INSPECTOR SHALL BE NOTIFIED BY THE CONTRACTOR WHEN THERE IS NEED OF INSPECTION AS REQUIRED BY THE INTERNATIONAL BUILDING CODE OR ANY LOCAL CODE OR ORDINANCE.

THESE DOCUMENTS ARE INTENDED TO INCLUDE ALL LABOR, MATERIALS, EQUIPMENT AND SERVICES REQUIRED TO COMPLETE THE WORK DESCRIBED HEREIN.


THE CONTRACTOR SHALL CAREFULLY STUDY AND COMPARE THE DOCUMENTS, VERIFY ACTUAL CONDITIONS AND REPORT ANY DISCREPENCIES, ERRORS OR OMMISSIONS TO THE ARCHITECT IN A TIMELY MANNER. THE ARCHITECT SHALL CLARIFY OR PROVIDE REASONABLE ADDITIONAL INFORMATION REQUIRED FOR SUCCESSFUL EXECUTION. THE CONTRACTOR SHALL VERIFY AND COORDINATE ALL OPENINGS THROUGH FLOORS, CEILINGS AND WALLS WITH ALL ARCHITECTURAL, INTERIOR, STRUCTURAL, MECHANICAL AND PLUMBING, ELECTRICAL AND LIGHTING DRAWINGS. CONTRACTOR WILL ASSUME RESPONSIBILITY OF ITEMS REQUIRING COORDINATION AND RESOLUTION DURING THE BIDDING PROCESS.

ANY MATERIALS PROPOSED FOR SUBSTITUTION OF THOSE SPECIFIED OR THE CALLED OUT BY TRADE NAME IN THESE DOCUMENTS SHALL BE PRESENTED TO THE ARCHITECT FOR REVIEW. THE CONTRACTOR SHALL SUBMIT SAMPLES WHEN REQUIRED BY THE ARCHITECT AND SUCH SAMPLES SHALL BE REVIEWED BY THE ARCHITECT BEFORE THE WORK IS PERFORMED. WORK MUST CONFORM TO THE REVIEWED SAMPLES. ANY WORK WHICH DOES NOT CONFORM SHALL BE REMOVED AND REPLACED WITH WORK WHICH CONFORMS AT THE CONTRACTOR'S EXPENSE. SUBCONTRACTORS SHALL SUBMIT REQUESTS AND SAMPLES FOR REVIEW THROUGH THE GENERAL CONTRACTOR WHEN WORK IS LET THROUGH HIM OR HER. REQUIRED VERIFICATION AND SUBMITTALS TO BE MADE IN ADEQUATE TIME AS NOT TO DELAY WORK IN PROGRESS.

SHOP DRAWINGS SHALL BE SUBMITTED TO THE ARCHITECT FOR HIS OR HER REVIEW WHERE CALLED FOR ANYWHERE IN THESE DOCUMENTS. REVIEW SHALL BE MADE BY THE ARCHITECT BEFORE WORK IS BEGUN, AND WORK SHALL CONFORM TO THE REVIEWED SHOP DRAWINGS, SUBJECT TO REPLACEMENT AS REQUIRED IN PARAGRAPH "SUBSTITUTIONS" ABOVE.

SAFETY & PROTECTION OF WORK:

THE CONTRACTOR SHALL BE RESPONSIBLE FOR THE SAFETY AND CARE OF ADJACENT PROPERTIES DURING CONSTRUCTION FOR COMPLIANCE WITH FEDERAL AND STATE O.S.H.A. REGULATIONS, AND FOR THE PROTECTION OF ALL WORK UNTIL IT IS DELIVERED COMPLETED TO THE OWNER.

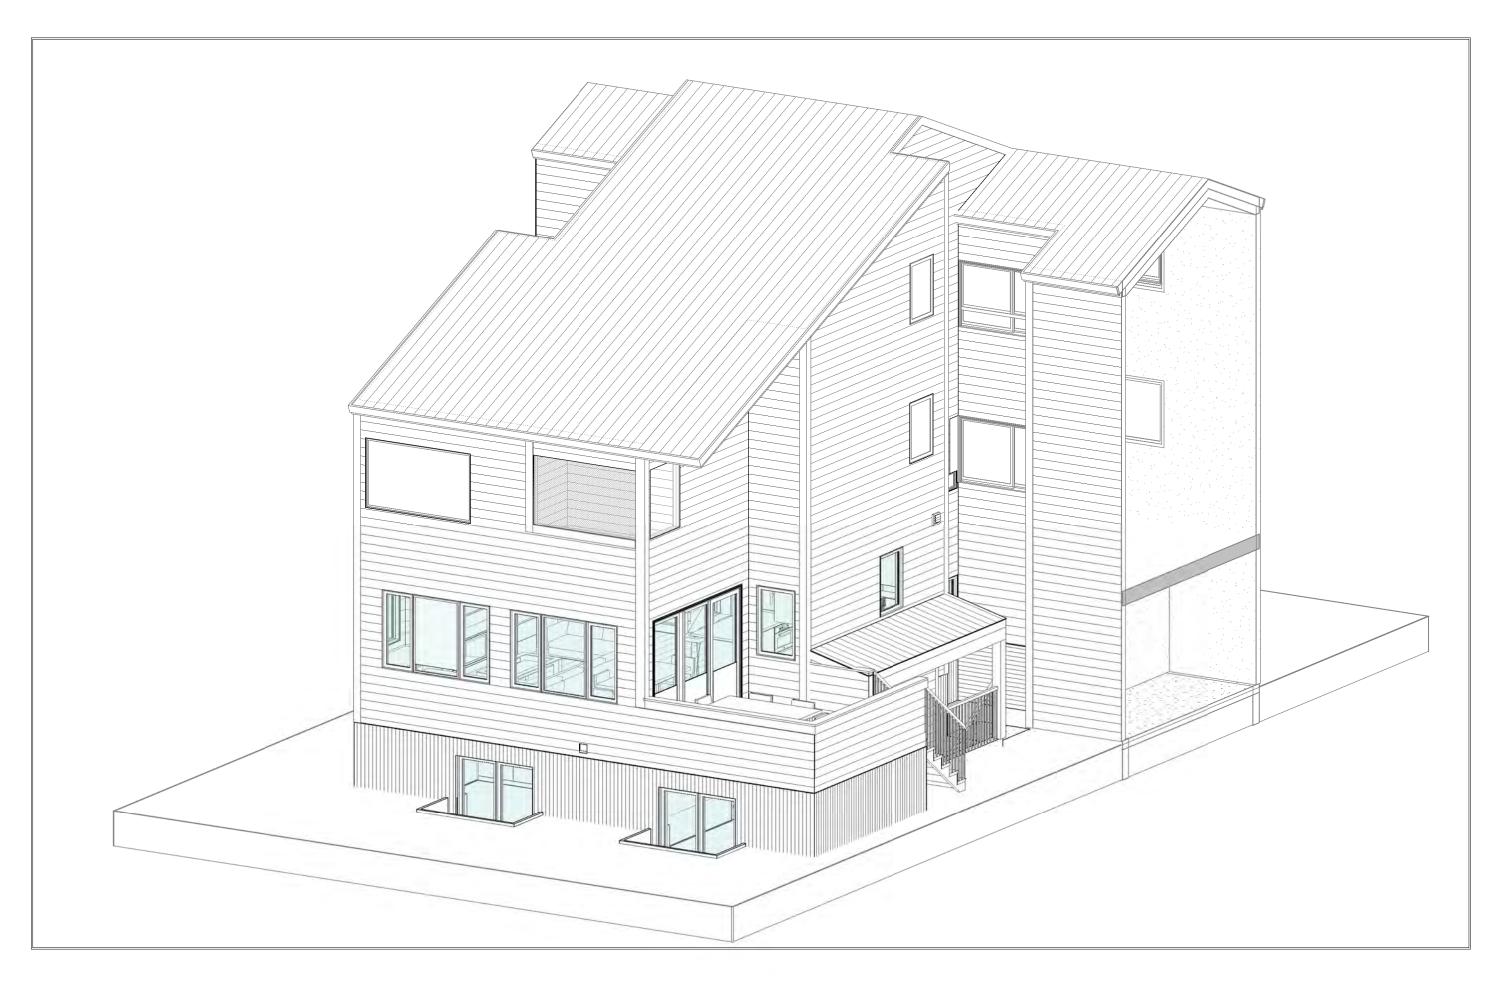

SHIF

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PROJECT CODE INFORMATION

ZONING TOWN OF TELLURIDE; ACCOMMODATIONS DISTRICT 2

BUILDING CODE IRC 2018

DESCRIPTION MULTI-LEVEL CONDO

AUTOMATIC FIRE SPRINKLER PER NFDA

SCOPE OF WORK NEW BASEMENT LEVEL W/ ENTRY, NEW LIVING SPACE UNDER EXISTING DECK, EXPAND

LIVING SPACE ON MAIN LEVEL TO EXTENTS OF EXISTING EXTERIOR WALL AND INTERIOR

RENOVATIONS AS NOTED

PROJECT INFORMATION


EXISTING MAIN LEVEL / ENTRY EXISITING DECK **EXISITING LOWER LEVEL** PROPOSED MAIN LEVEL / ENTRY PROPOSED DECK PROPOSED LOWER LEVEL PROPOSED BASEMENT **EXISTING FLOOR AREA**

PARKING REQUIRED 1 REQUIRED 1 PROVIDED

TYPE OF UNIT

507 SF 128 SF 535 SF 498 SF 635 SF 1,005 SF PROPOSED FLOOR AREA 1,668 SF

VICINITY MAP

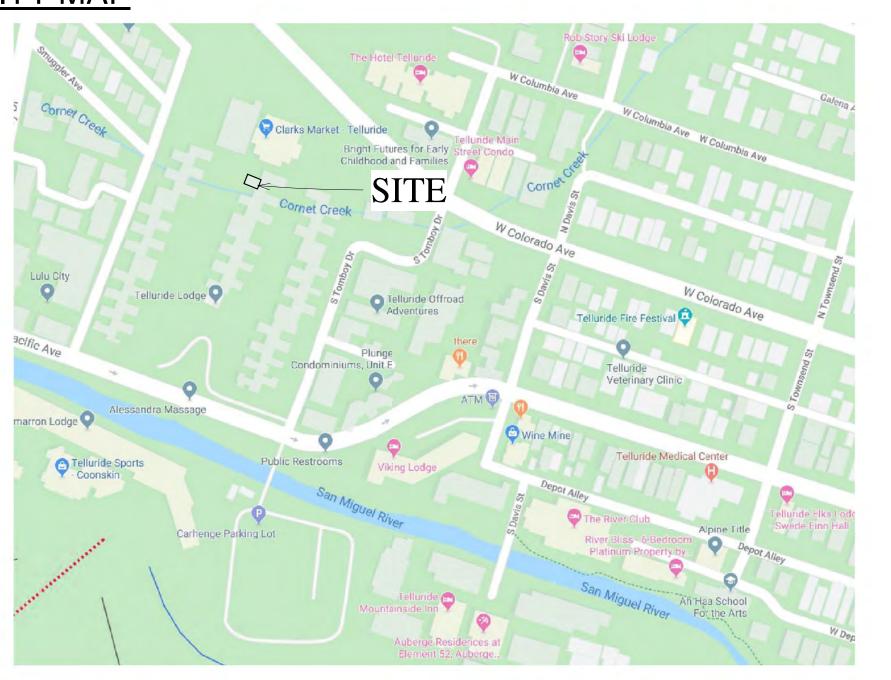

PROJECT TEAM

OWNER:

BROOKE MALLETTE & DAVID ROTHERMEL 747 W PACIFIC UNIT 402 TELLURIDE, CO 81435 P.303.810.7320

ARCHITECT:

SHIFT ARCHITECTS 100 W COLORADO STE. 211 TELLURIDE, CO 81435 P. 970.275.0263 kristine@shift-architects.com

GENERAL CONTRACTOR:

KEES INDUSTRIES, LLC BLAKE KEES PO BOX 462 PLACERVILLE, CO 81430 P. 970-729-1731 BLAKEGKEES@GMAIL.COM

STRUCTURAL:

TELLURIDE ENGINEERING LLC PO BOX 4045 TELLURIDE, CO 81435 P. 970.728.5440 JGARDNER.PE@GMAIL.COM

SHEET INDEX

GENERAL

COVER SHEET ABBREVIATIONS & LEGENDS ARCHITECTURAL

DEMO PLAN D1.1 A3.1 EXISTING FLOOR PLAN PROPOSED FLOOR PLANS A3.2 FRAMING PLANS A3.3 **EXISTING ELEVATIONS** A4.1 PROPOSED ELEVATIONS A4.2 SECTION A5.1 WALL DETAILS A7.1 FLASHING DETAILS A7.2 A7.3 FLASHING DETAILS WINDOW / DOOR DETAILS A7.4 **DETAILS** A7.5 SEALING DETAILS A7.6 DOOR / WINDOW SCHEDULE A8.1 A8.2 SCHEDULES A9.1 INTERIOR ELEVATIONS A9.2 INTERIOR ELEVATIONS LIGHTING PLANS LTG1.1 STRUCTURAL

S1

S2

S3

STRUCTURAL NOTES

FLOOR FRAMING PLANS

FLOOR FRAMING PLANS


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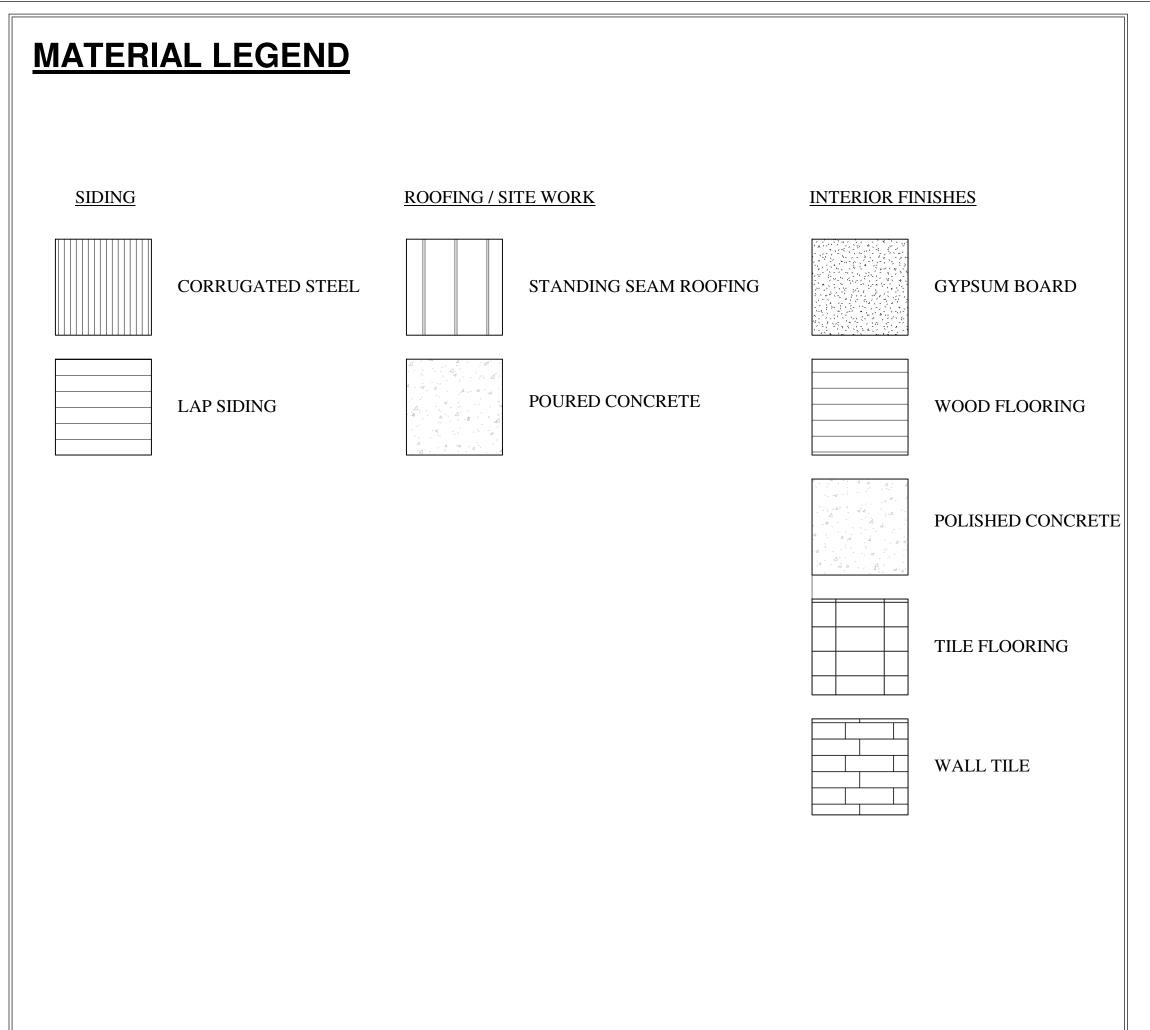
S


COVER SHEET


SHEET NUMBER

G1.0



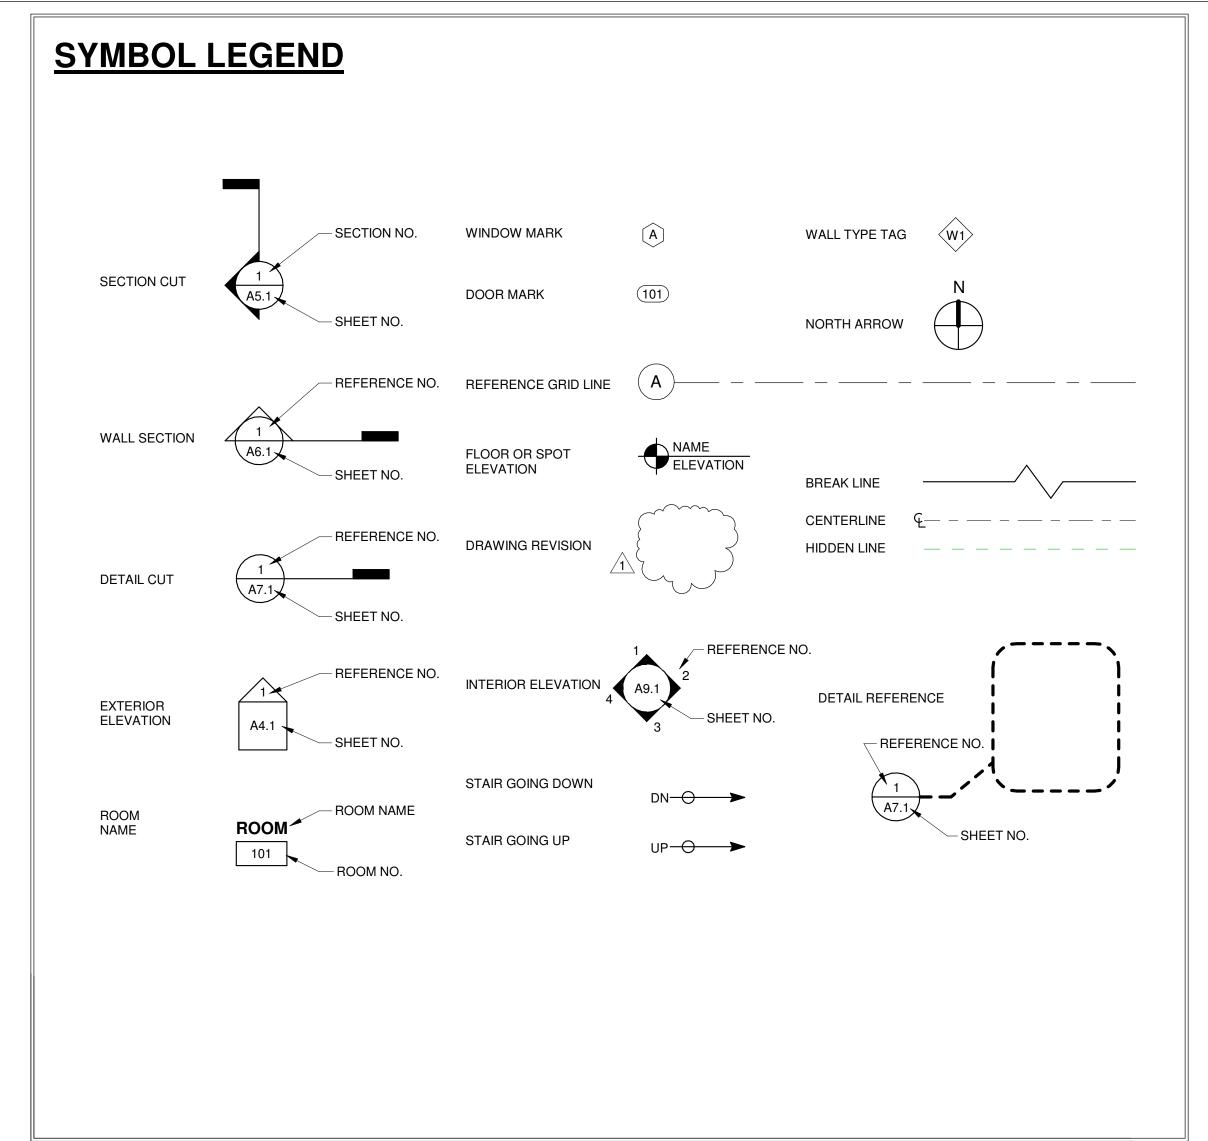

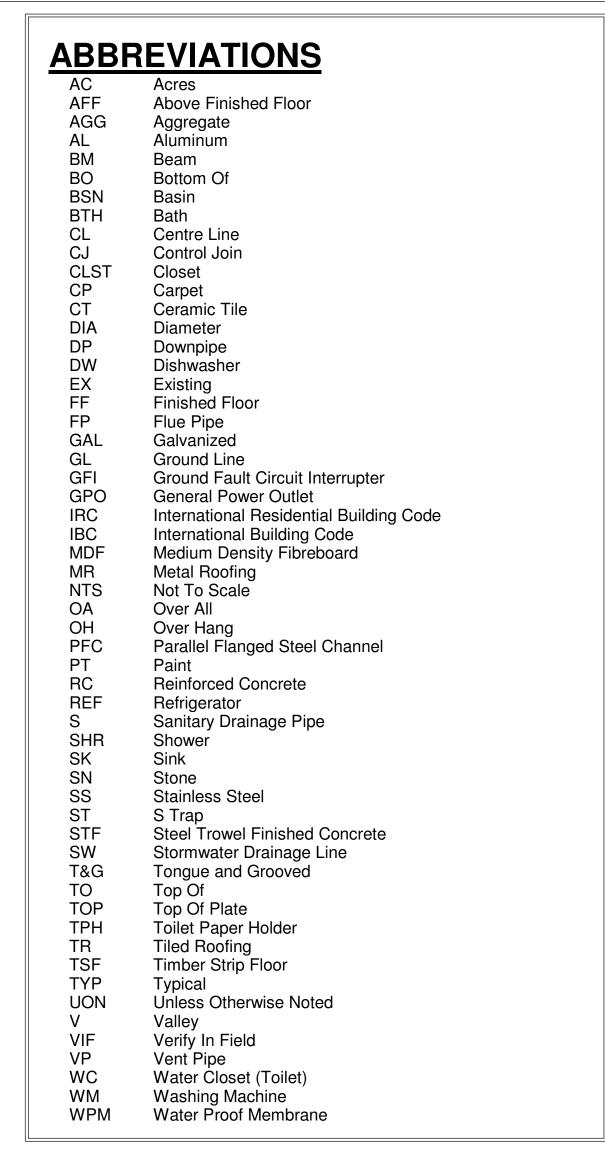

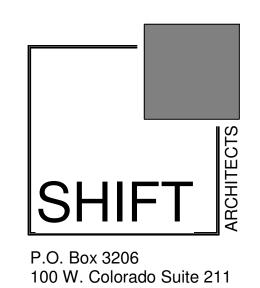



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DEMOLITION KEYED NOTES:


- EXISTING KITCHEN AND APPLIANCES TO BE REMOVED
- EXISTING WINDOWS TO BE REMOVED
- 3. EXISTING FLOOR FINISHES TO BE REMOVED
- 4. EXISTING SIDING TO BE REMOVED AS NECESSARY5. EXISTING PLUMBING FIXTURES TO BE REMOVED
- 6. EXISTING INTERIOR AND EXTERIOR WALLS TO BE REMOVED AS SHOWN
- 7. EXISTING FOUNDATION UNDER MAIN LEVEL TO BE REMOVED
- 8. EXISTING DECK TO BE REMOVED
- 9. INTERIOR AND EXTERIOR DOORS TO BE REMOVED. ENTRY DOOR FROM HALL TO REMAIN

GENERAL DEMOLITION NOTES:

- DEMOLITION INDICATED IS FOR GENERAL REFERENCE PURPOSES ONLY AND IS NOT INTENDED TO IDENTIFY ALL OF THE DEMOLITION, REMOVAL OF FINISHES, ETC. GENERAL CONTRACTOR SHALL BE RESPONSIBLE FOR ALL DEMOLITION NECESSARY TO ACCOMMODATE NEW WORK WHETHER INDICATED OR NOT.
- THE CONTRACTOR MUST ADHERE TO THE SCOPE OF WORK SHOWN ON THE DRAWINGS. NO WORK IS AUTHORIZED IF IT EXPANDS THE ORIGINAL SCOPE OF WORK UNLESS IT IS APPROVED IN WRITING BY THE OWNER/ARCHITECT. ANY WORK UNDERTAKEN BY THE CONTRACTOR AND ANY ADDITIONAL REQUIRED DOCUMENTATION OR COST TO THE PROJECT WITHOUT PRIOR WRITTEN APPROVAL IS THE SOLE RESPONSIBILITY OF THE CONTRACTOR.
- VERIFY EXISTING STRUCTURE PRIOR TO DEMOLITION.
- ANY DISCREPANCIES ARE TO BE BROUGHT TO THE ATTENTION OF THE ARCHITECT.
- PROTECT ALL AREAS OF EXTERIOR FINISH ADJACENT TO DEMOLISHED ELEMENTS. PATCH AND REPAIR TO MATCH EXISTING CONDITIONS IF AFFECTED DURING CONSTRUCTION.

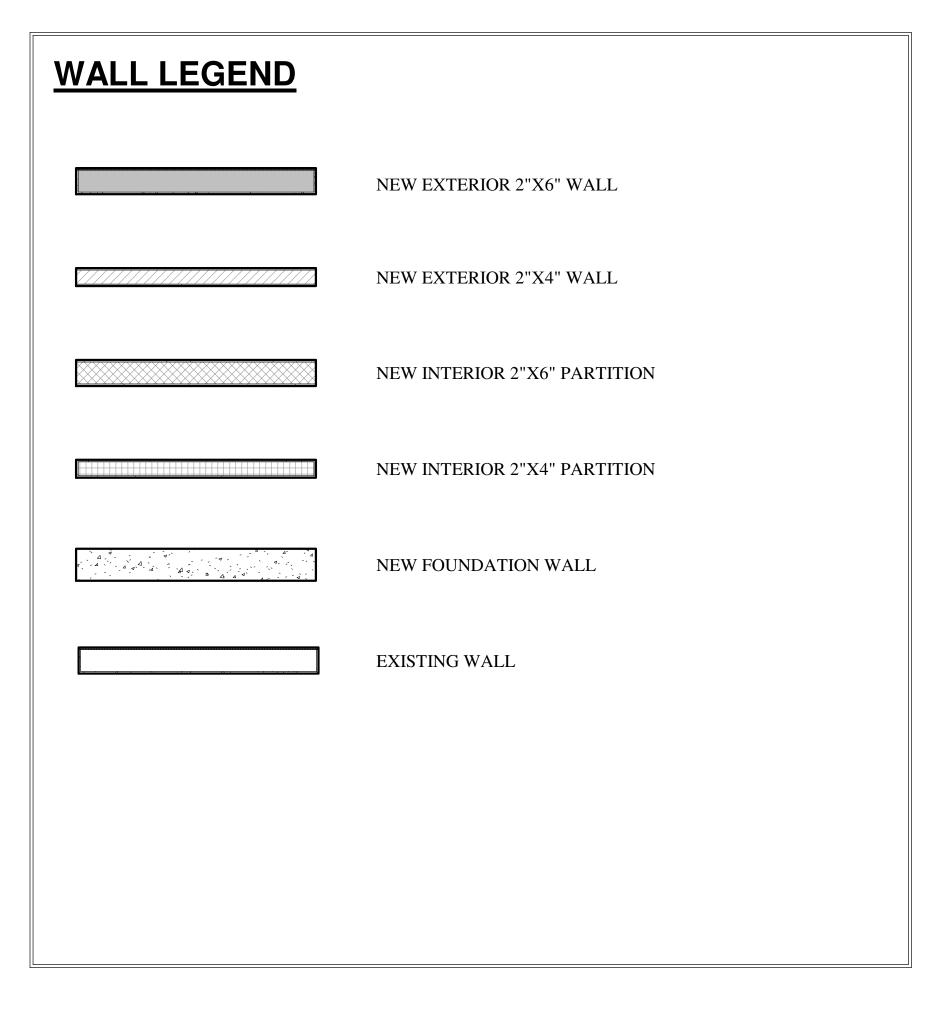____ _ DASHED LINES INDICATE REMOVAL OF EXISTING

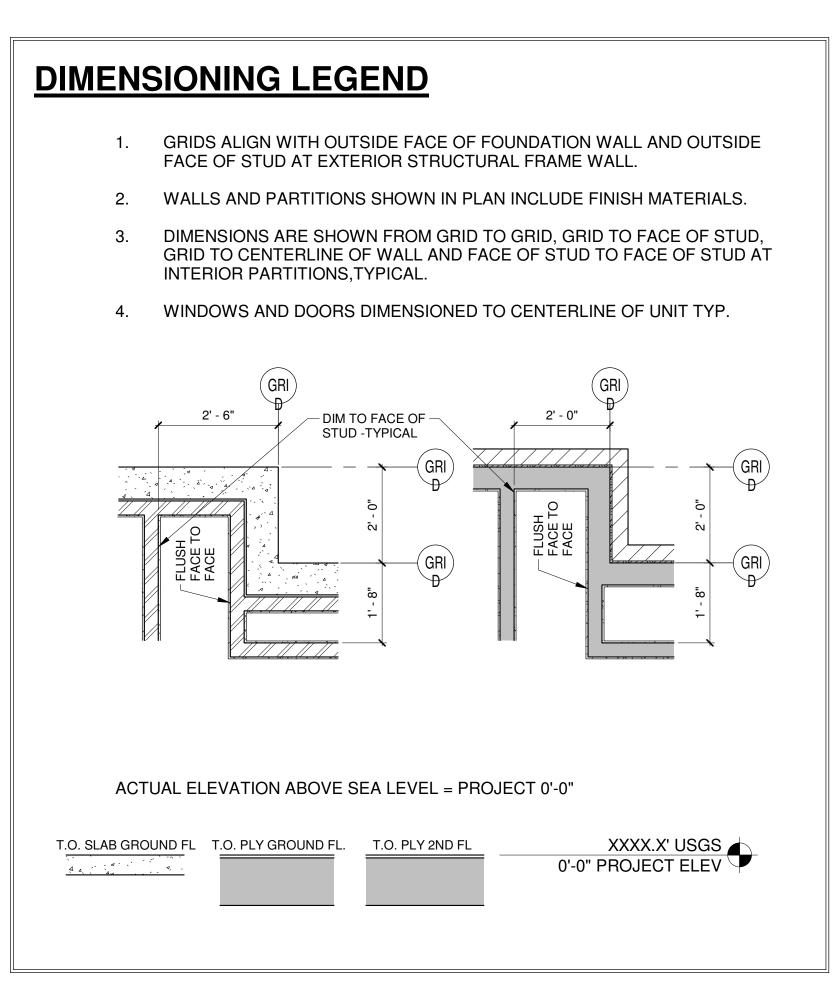EXISTING WALLS TO REMAIN

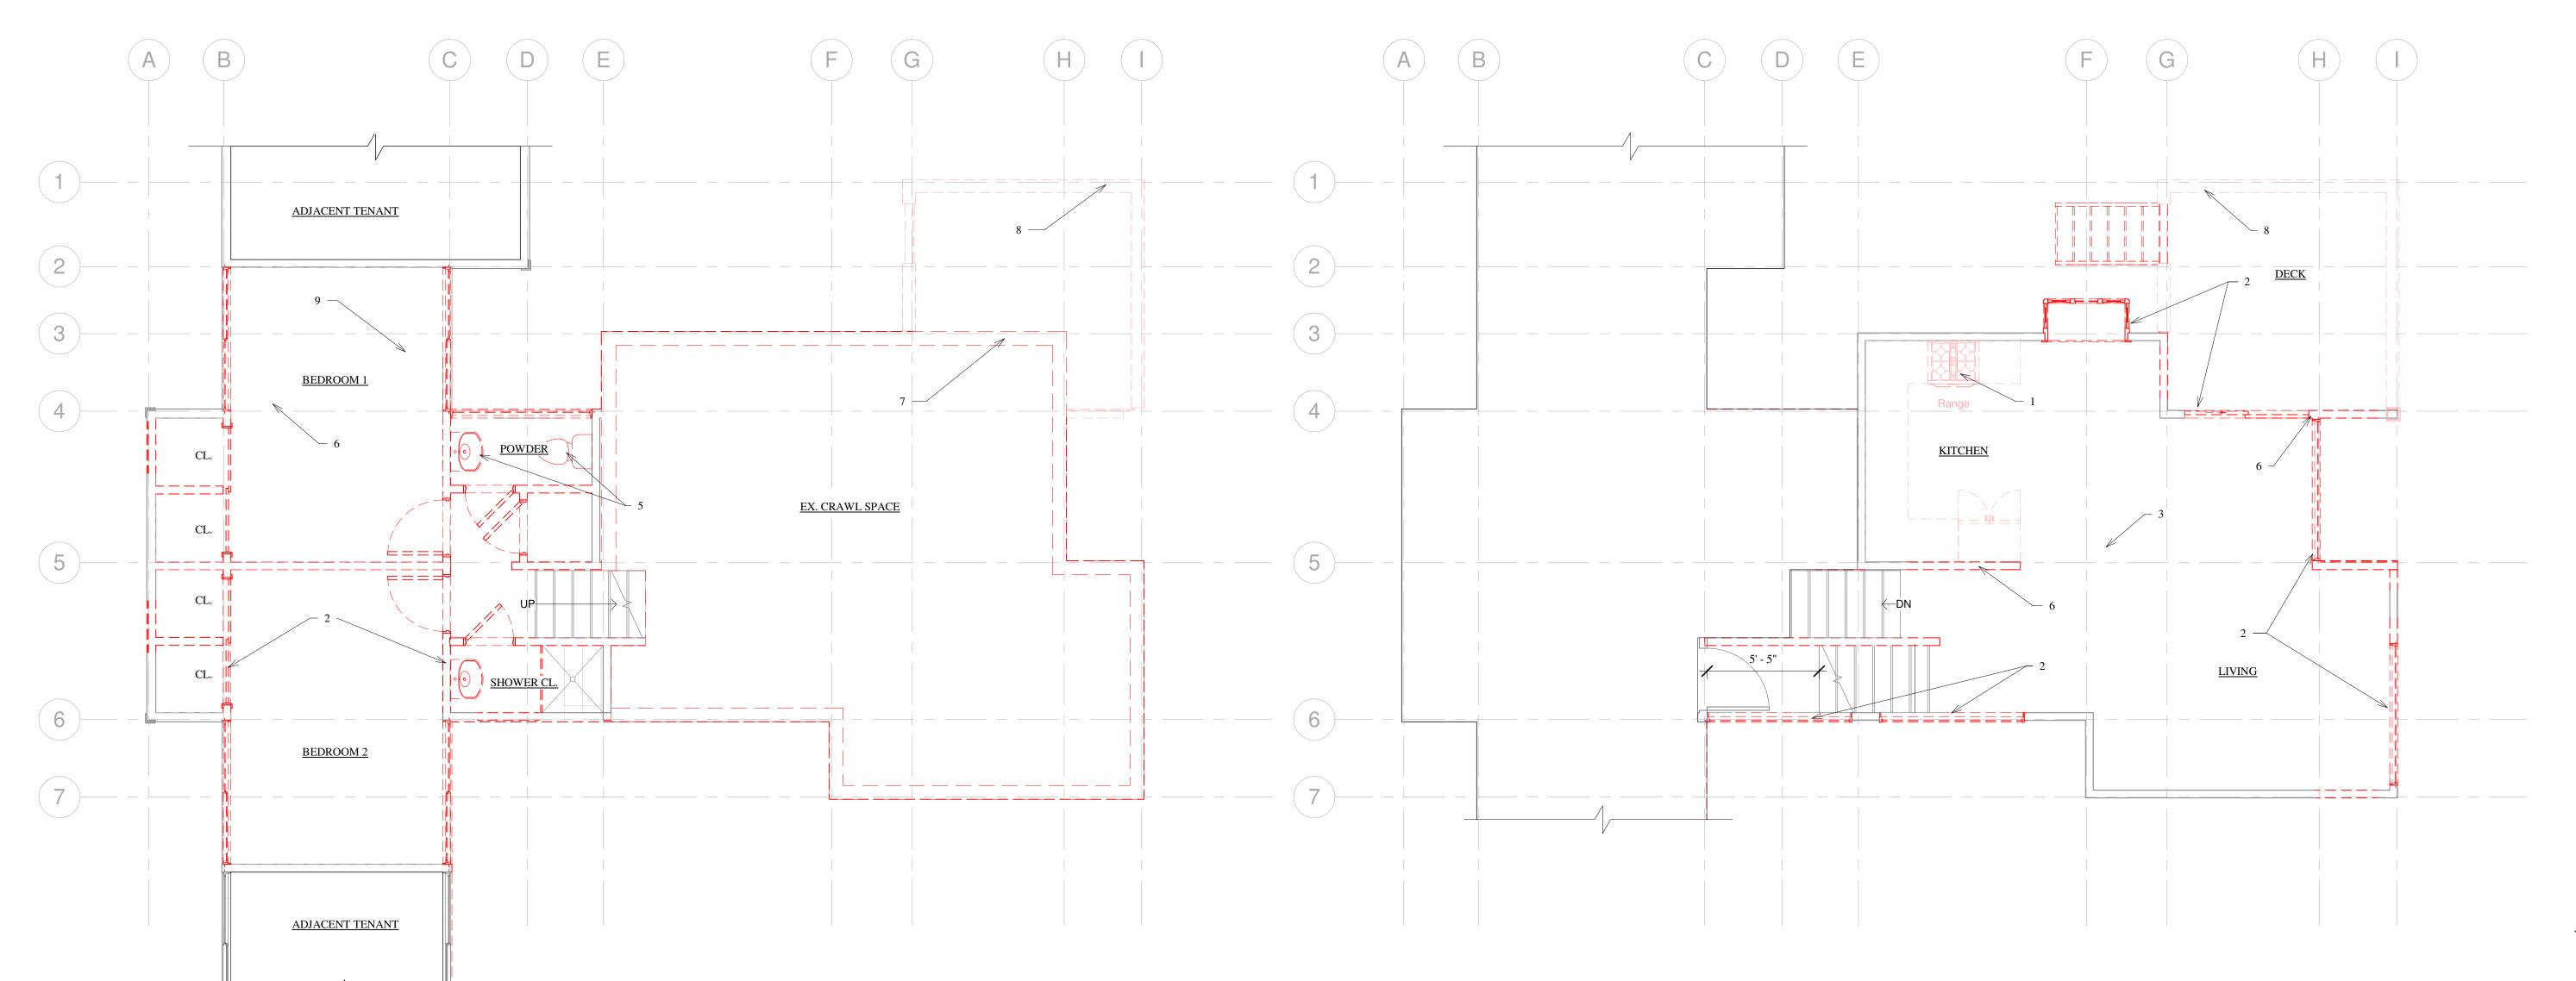

1) LOWER LEVEL DEMO PLAN 1/4" = 1'-0" 2 MAIN LEVEL DEMO PLAN
1/4" = 1'-0"

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IALLETTE RESIDENCE

DEMO PLAN

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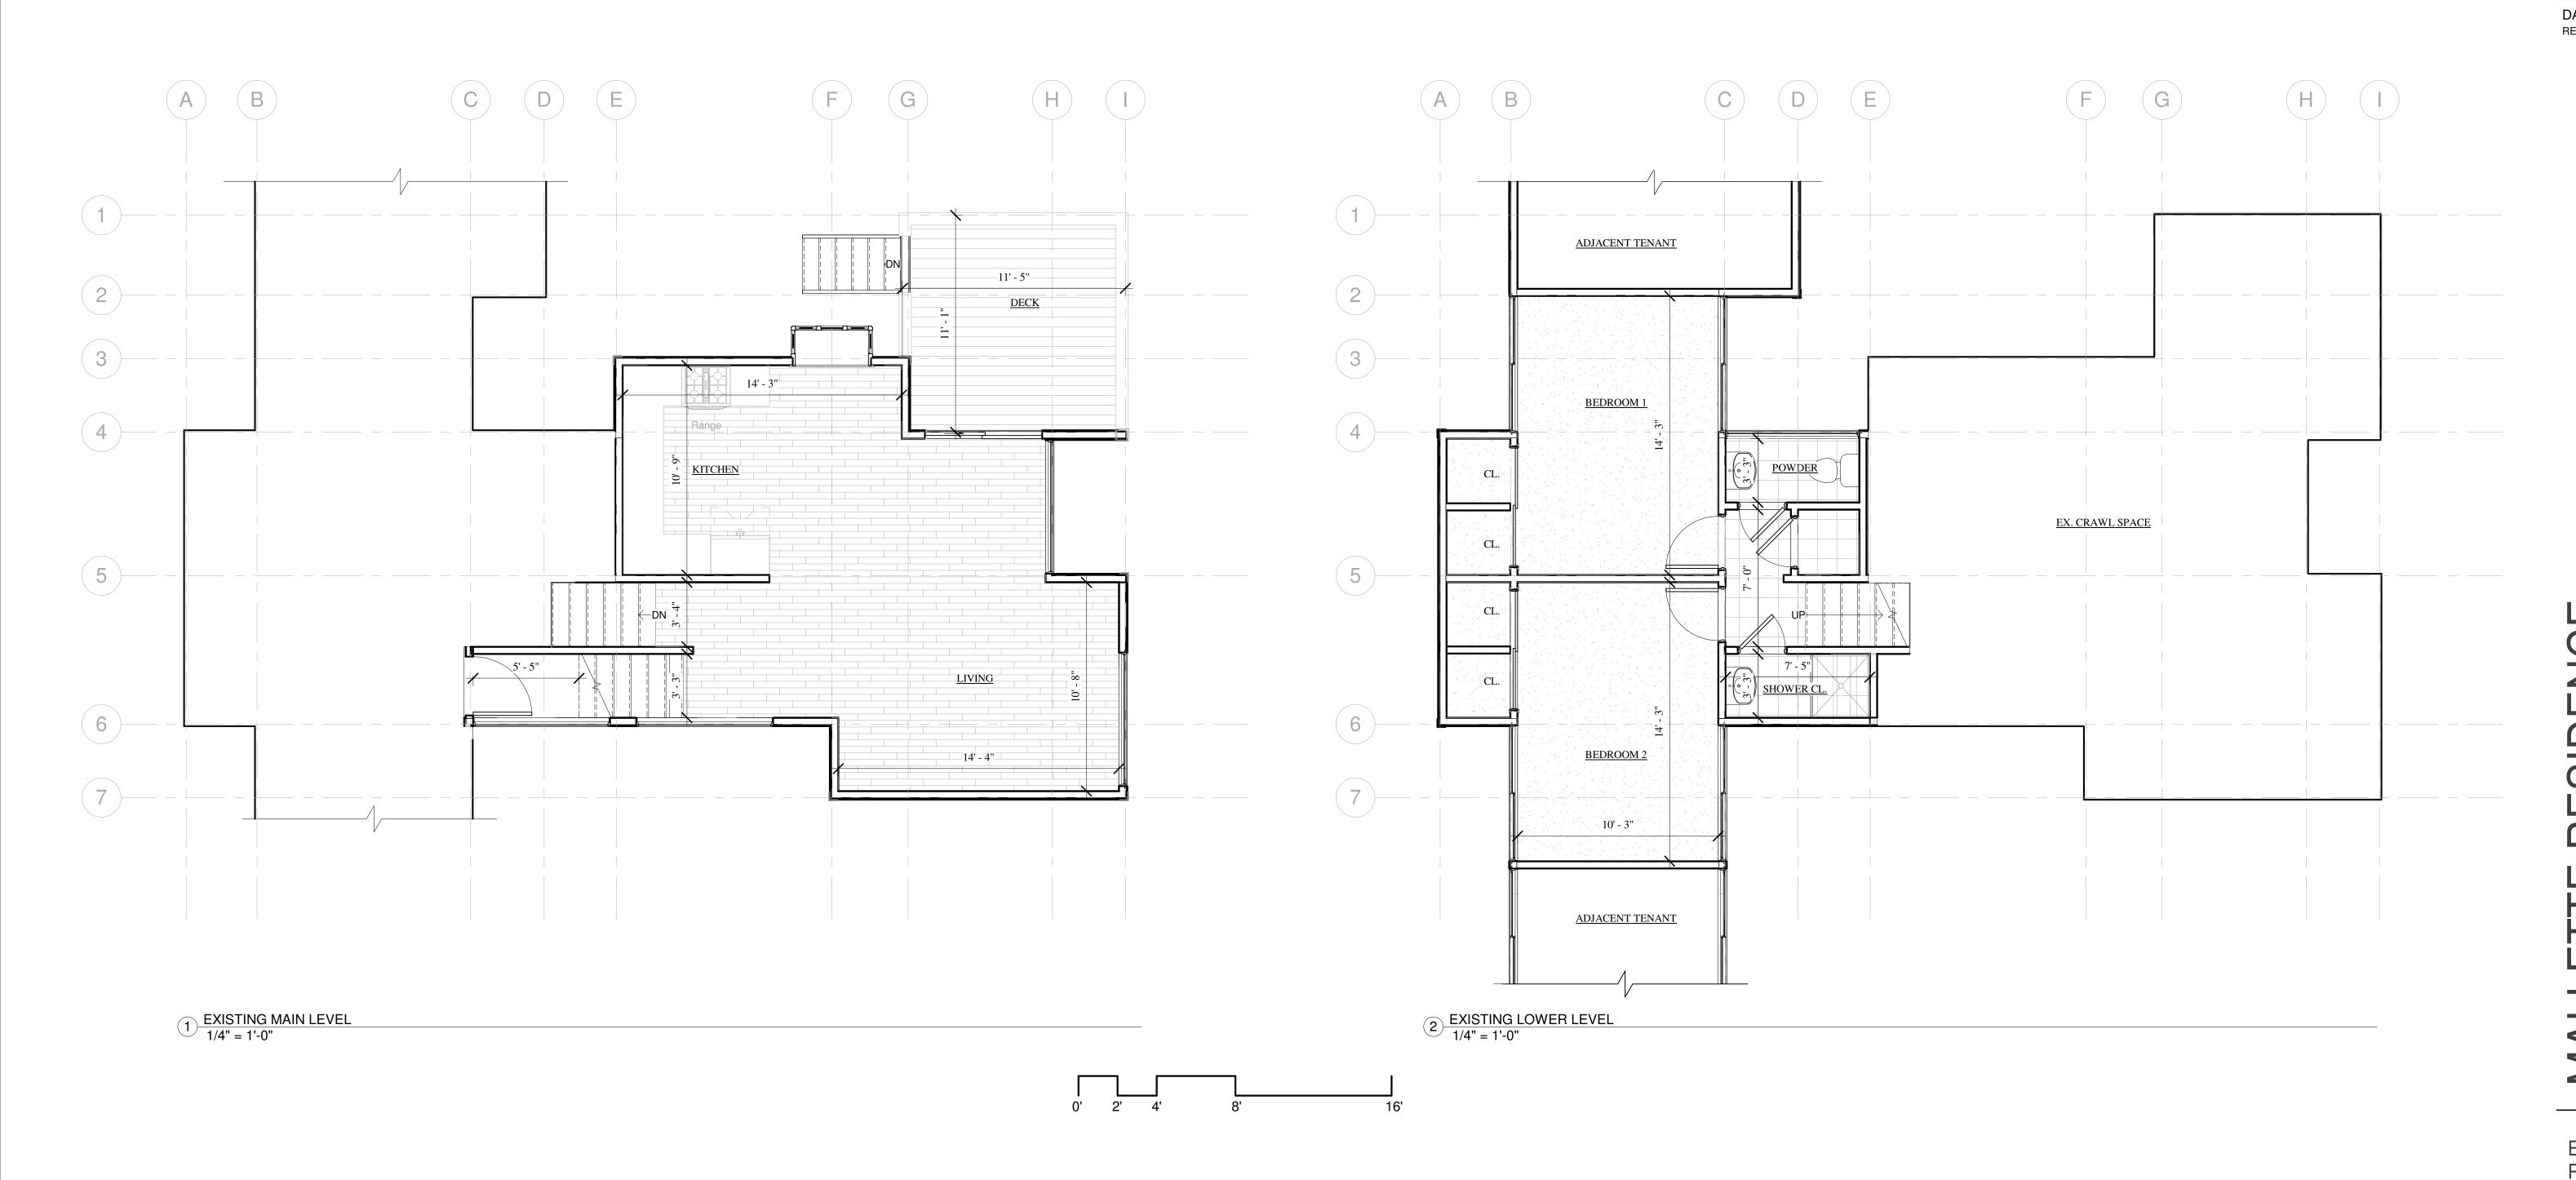
RESIDENCE


W PACIFIC AVE UNIT 402

EXISTING FLOOR PLAN

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A3.1



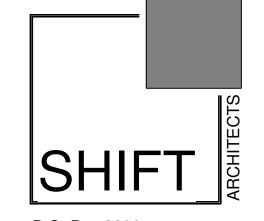

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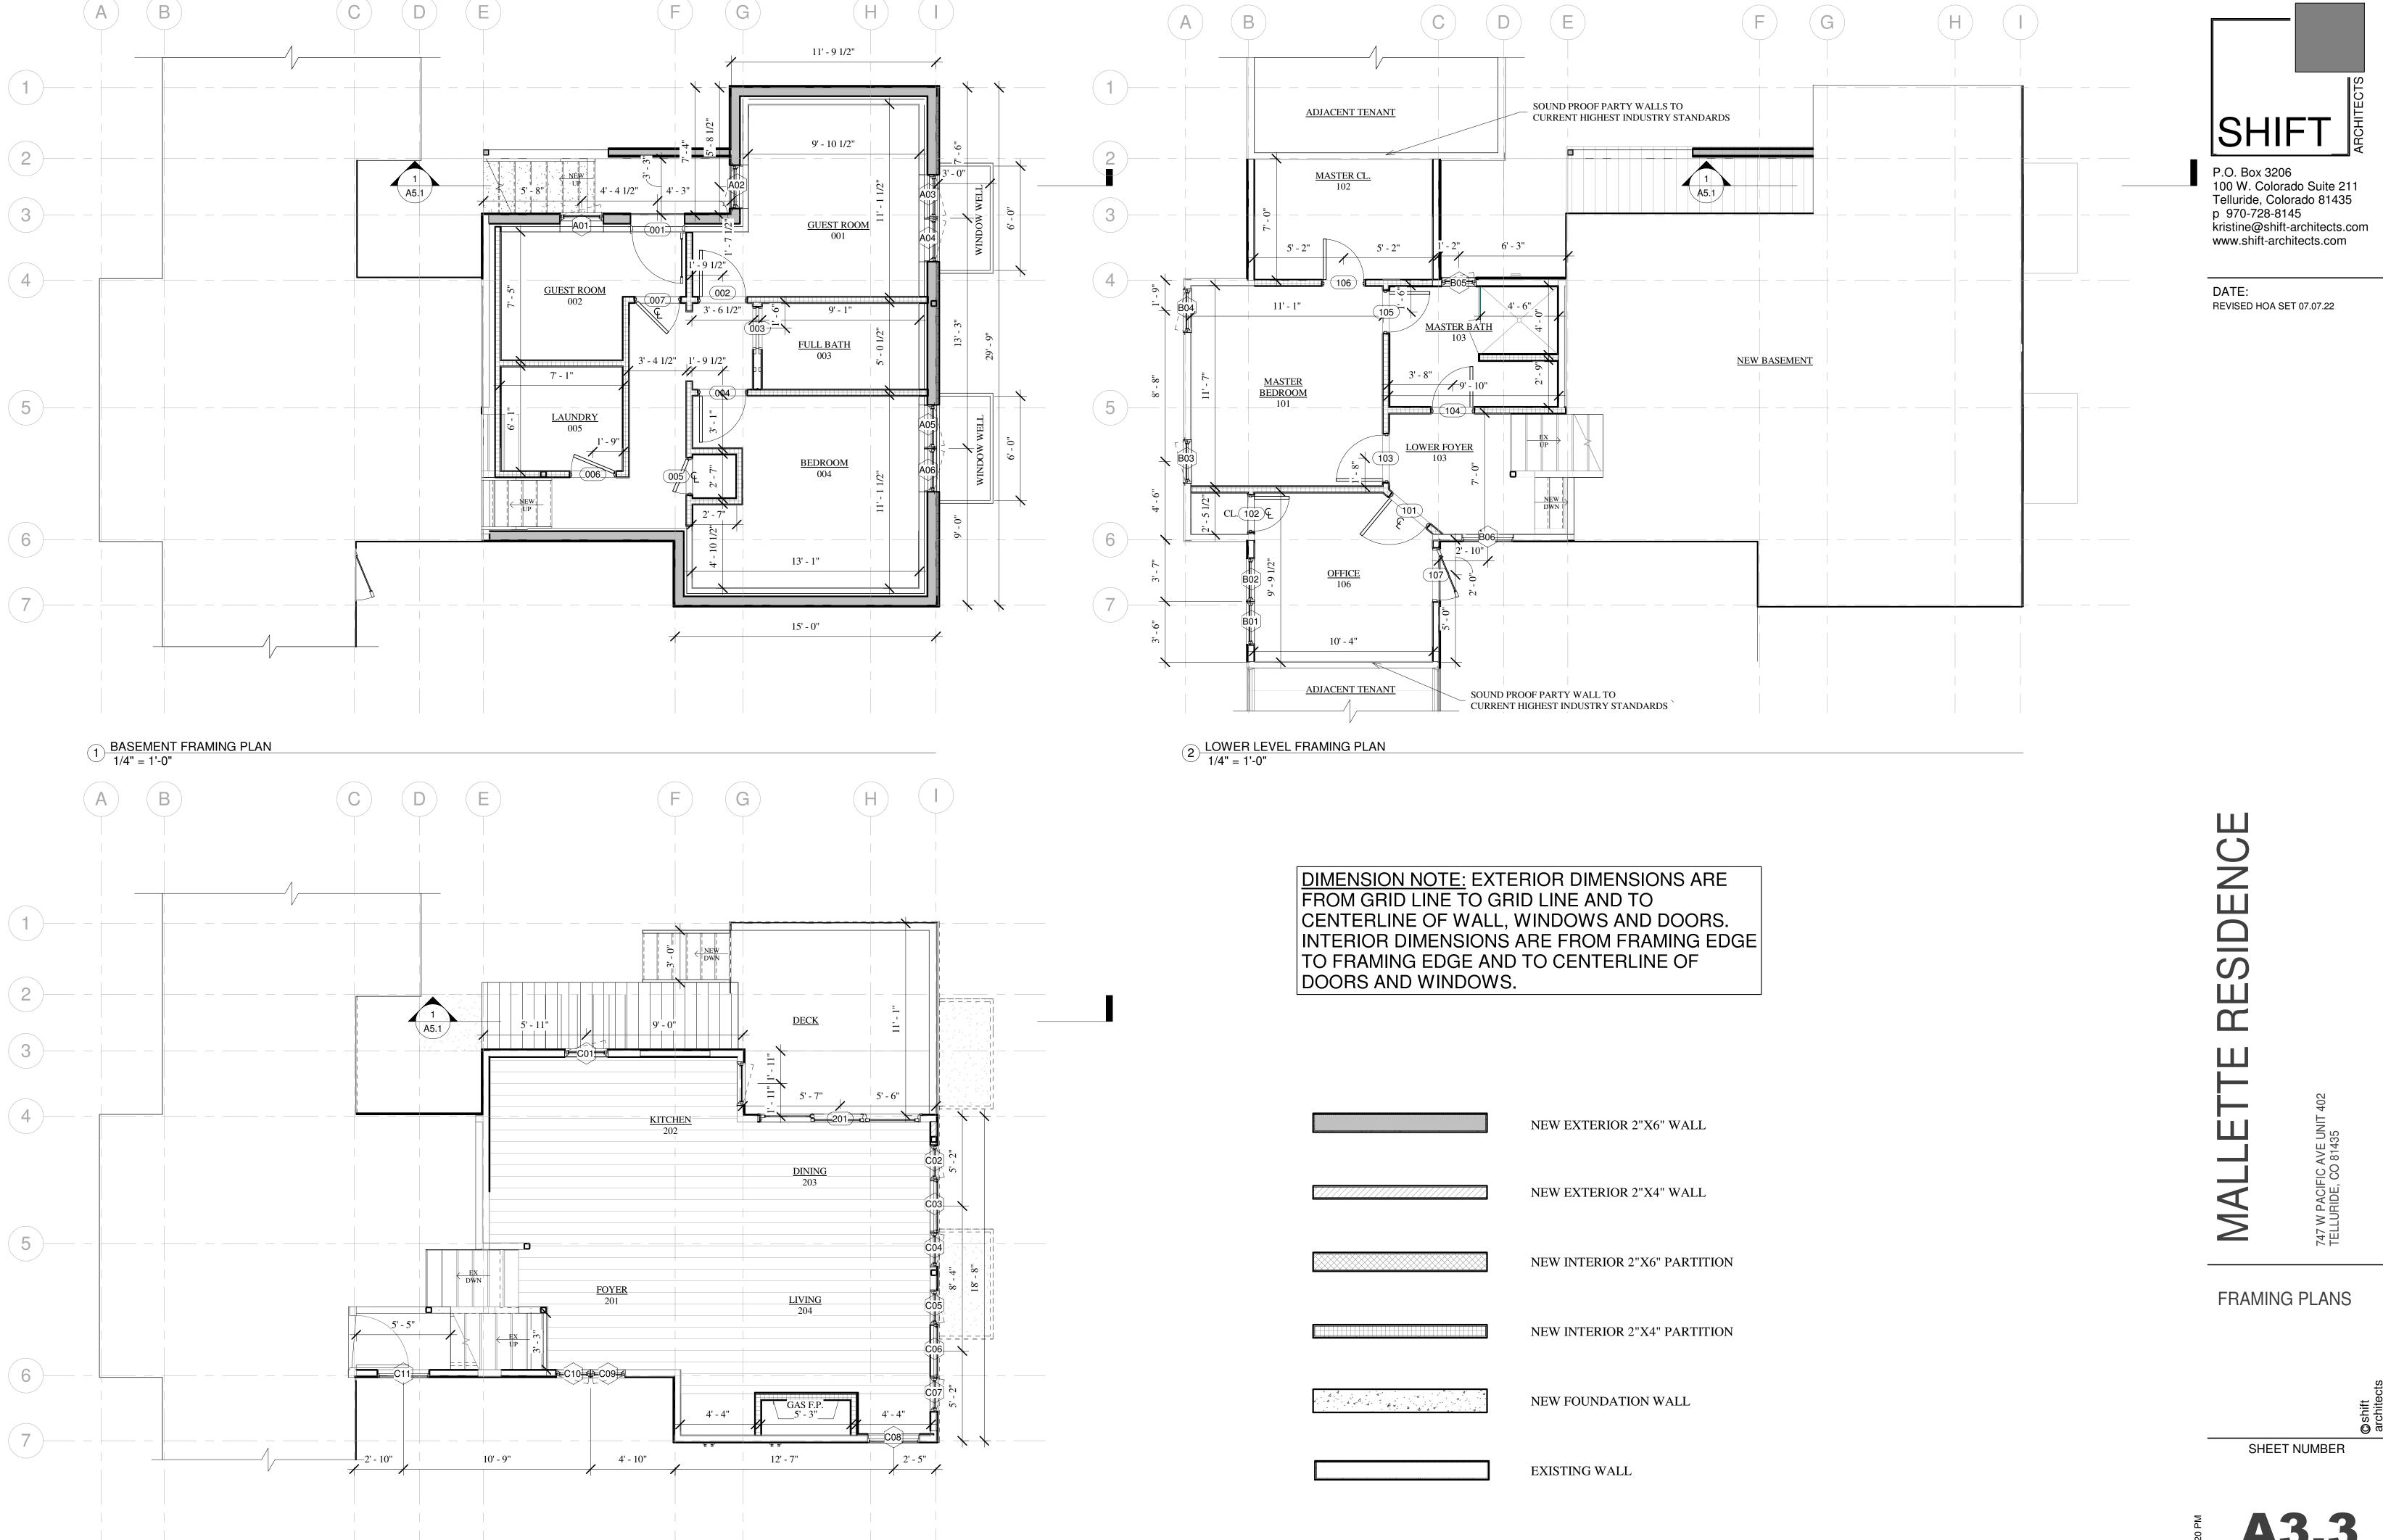
ETTE RESIDENCE

747 W PACIFIC AVE UNIT A

PROPOSED FLOOR PLANS

SHEET NUMBER


A3.2




MAIN LEVEL FRAMING PLAN
1/4" = 1'-0"

A3.3

WEST EXISTING			
1/4" = 1'-0"			_

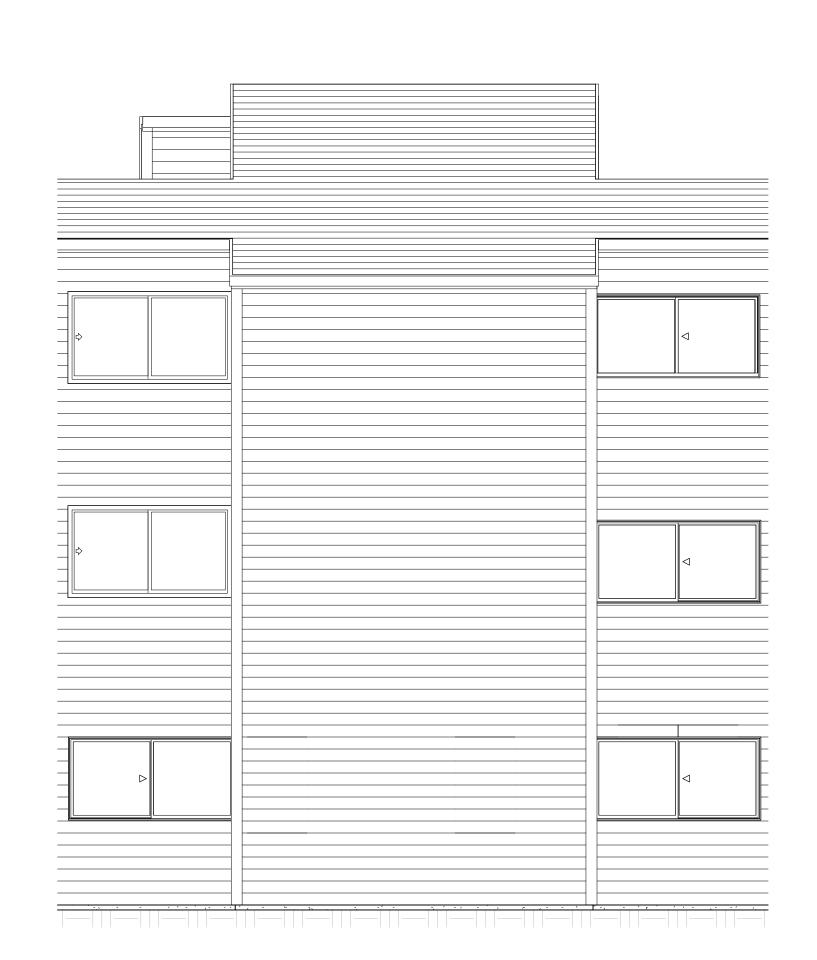

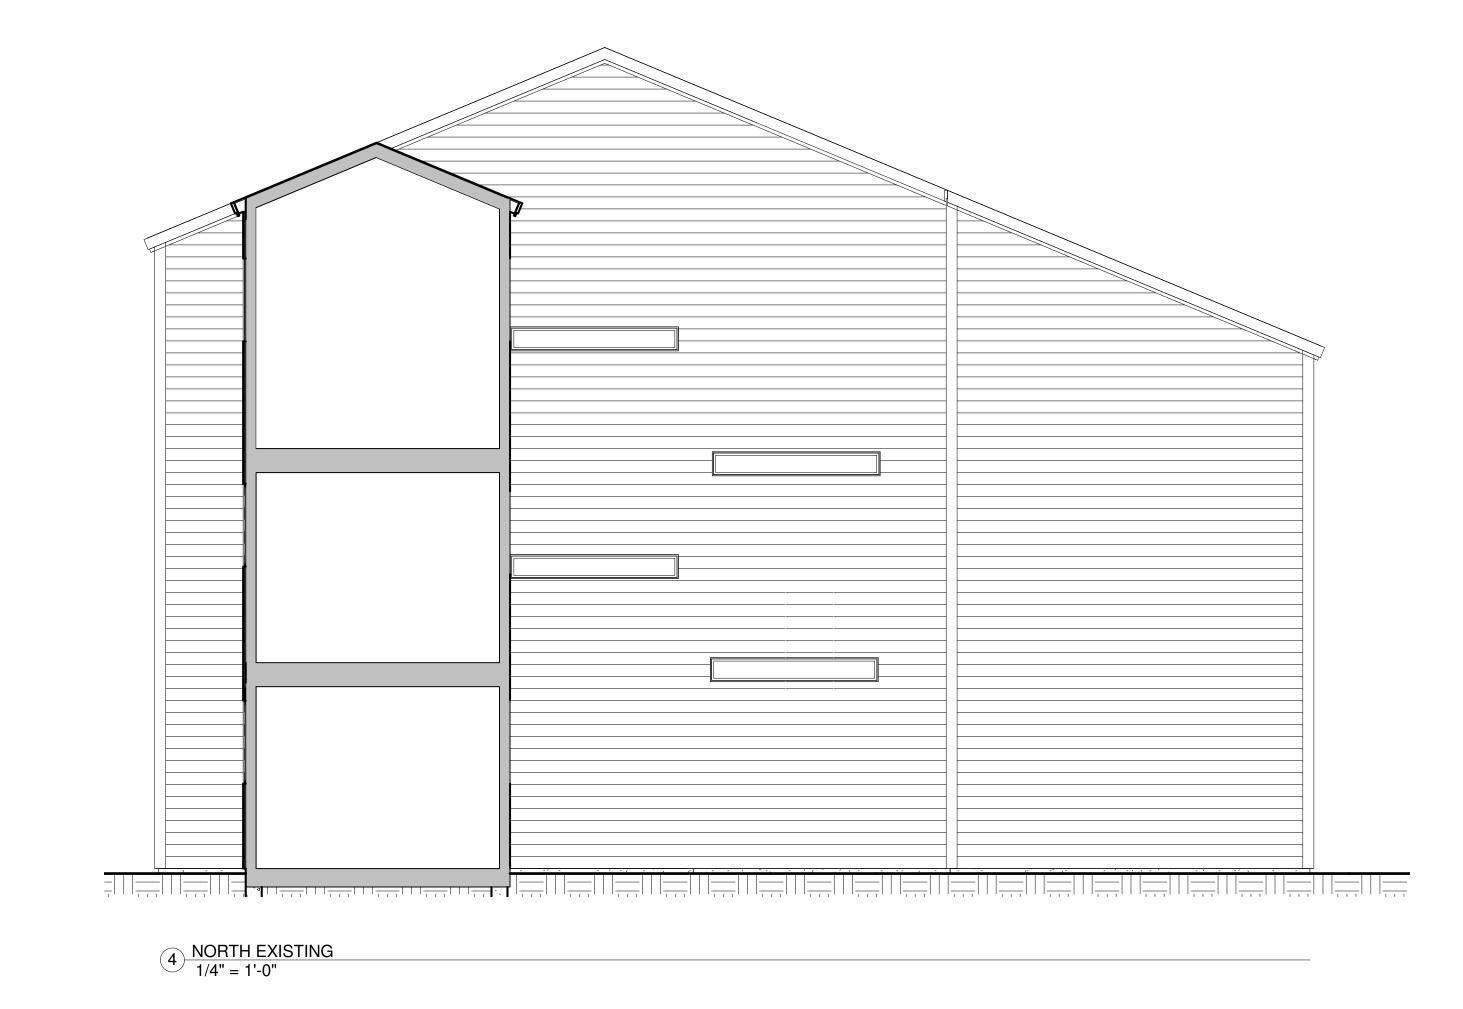



ETTE RESIDENCE

W PACIFIC AVE UNIT 402

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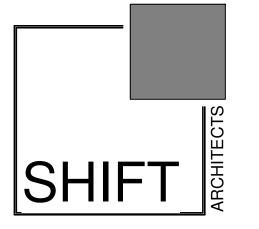
REVISED HOA SET 07.07.22

DATE:

EXISTING ELEVATIONS

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A4.1




REVISED HOA SET 07.07.22

PROPOSED ELEVATIONS

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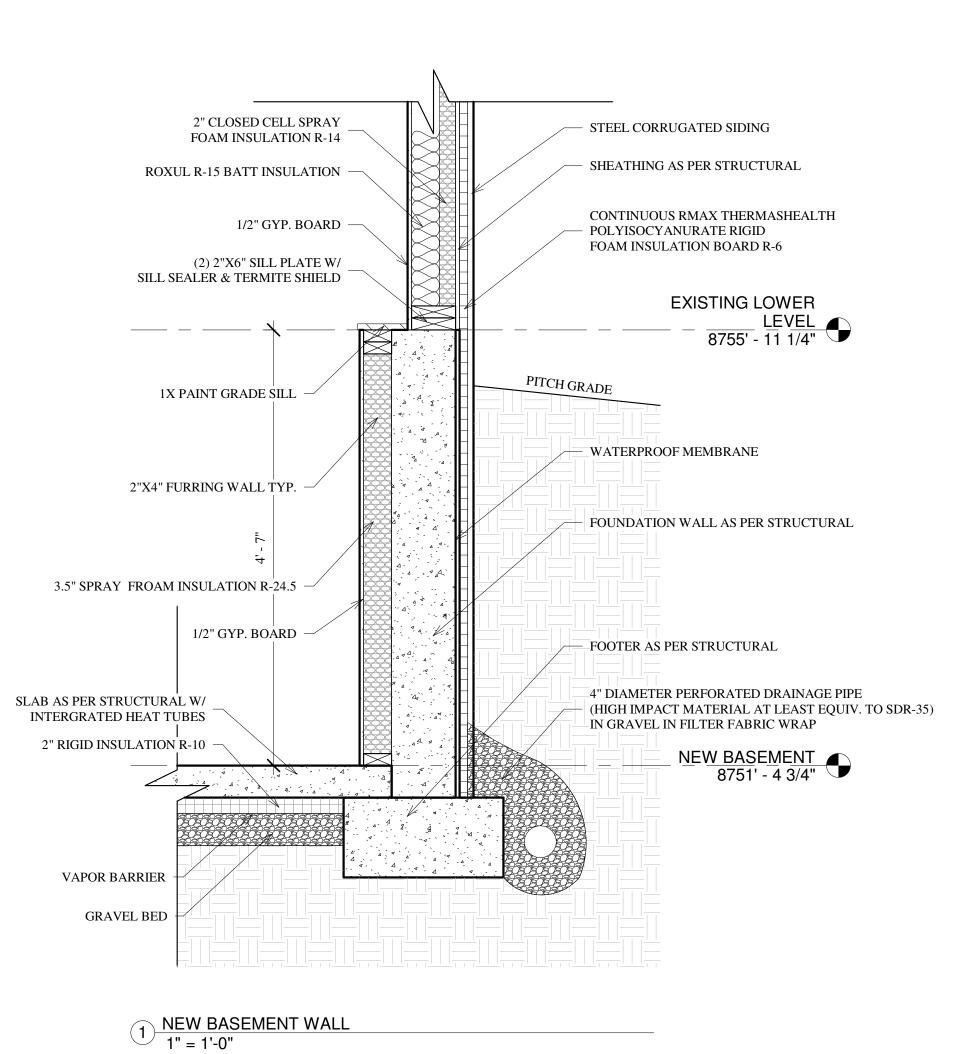
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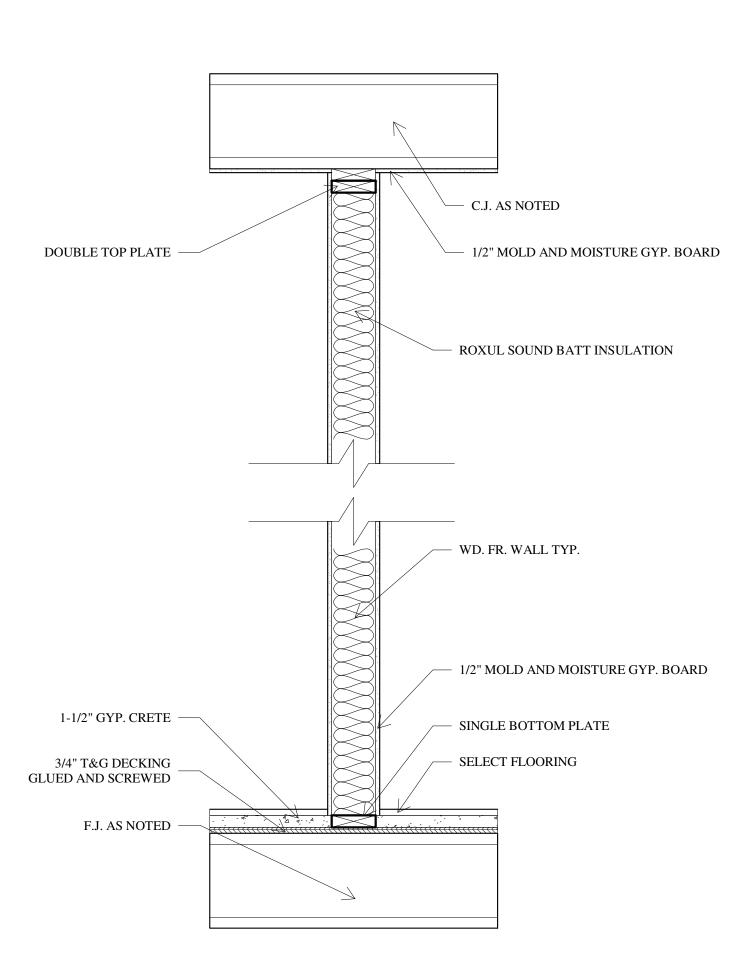
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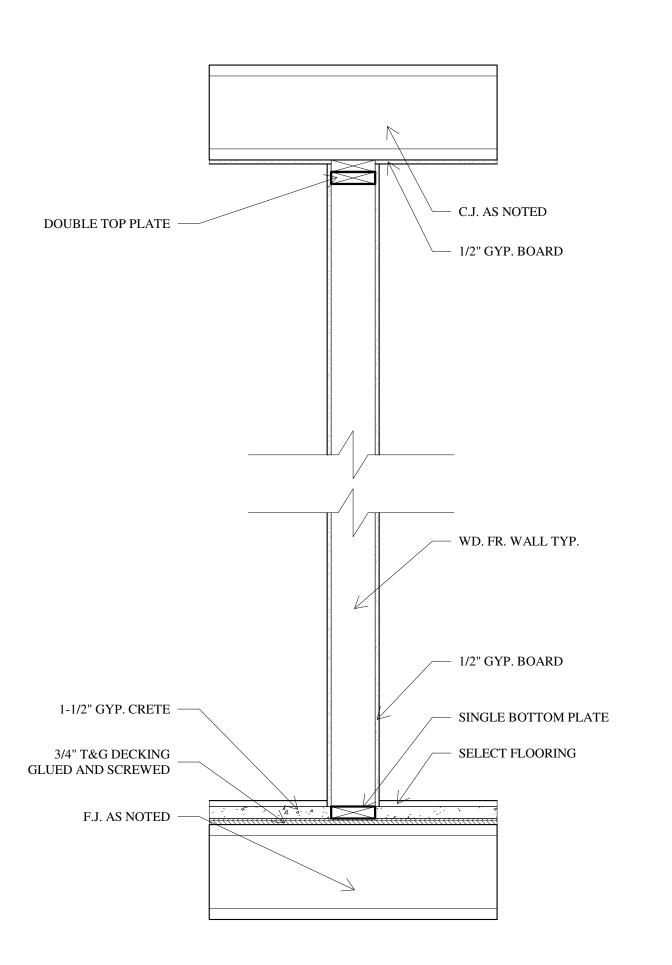
1) DECK OVER LIVING SPACE 1/2" = 1'-0"

A5.1




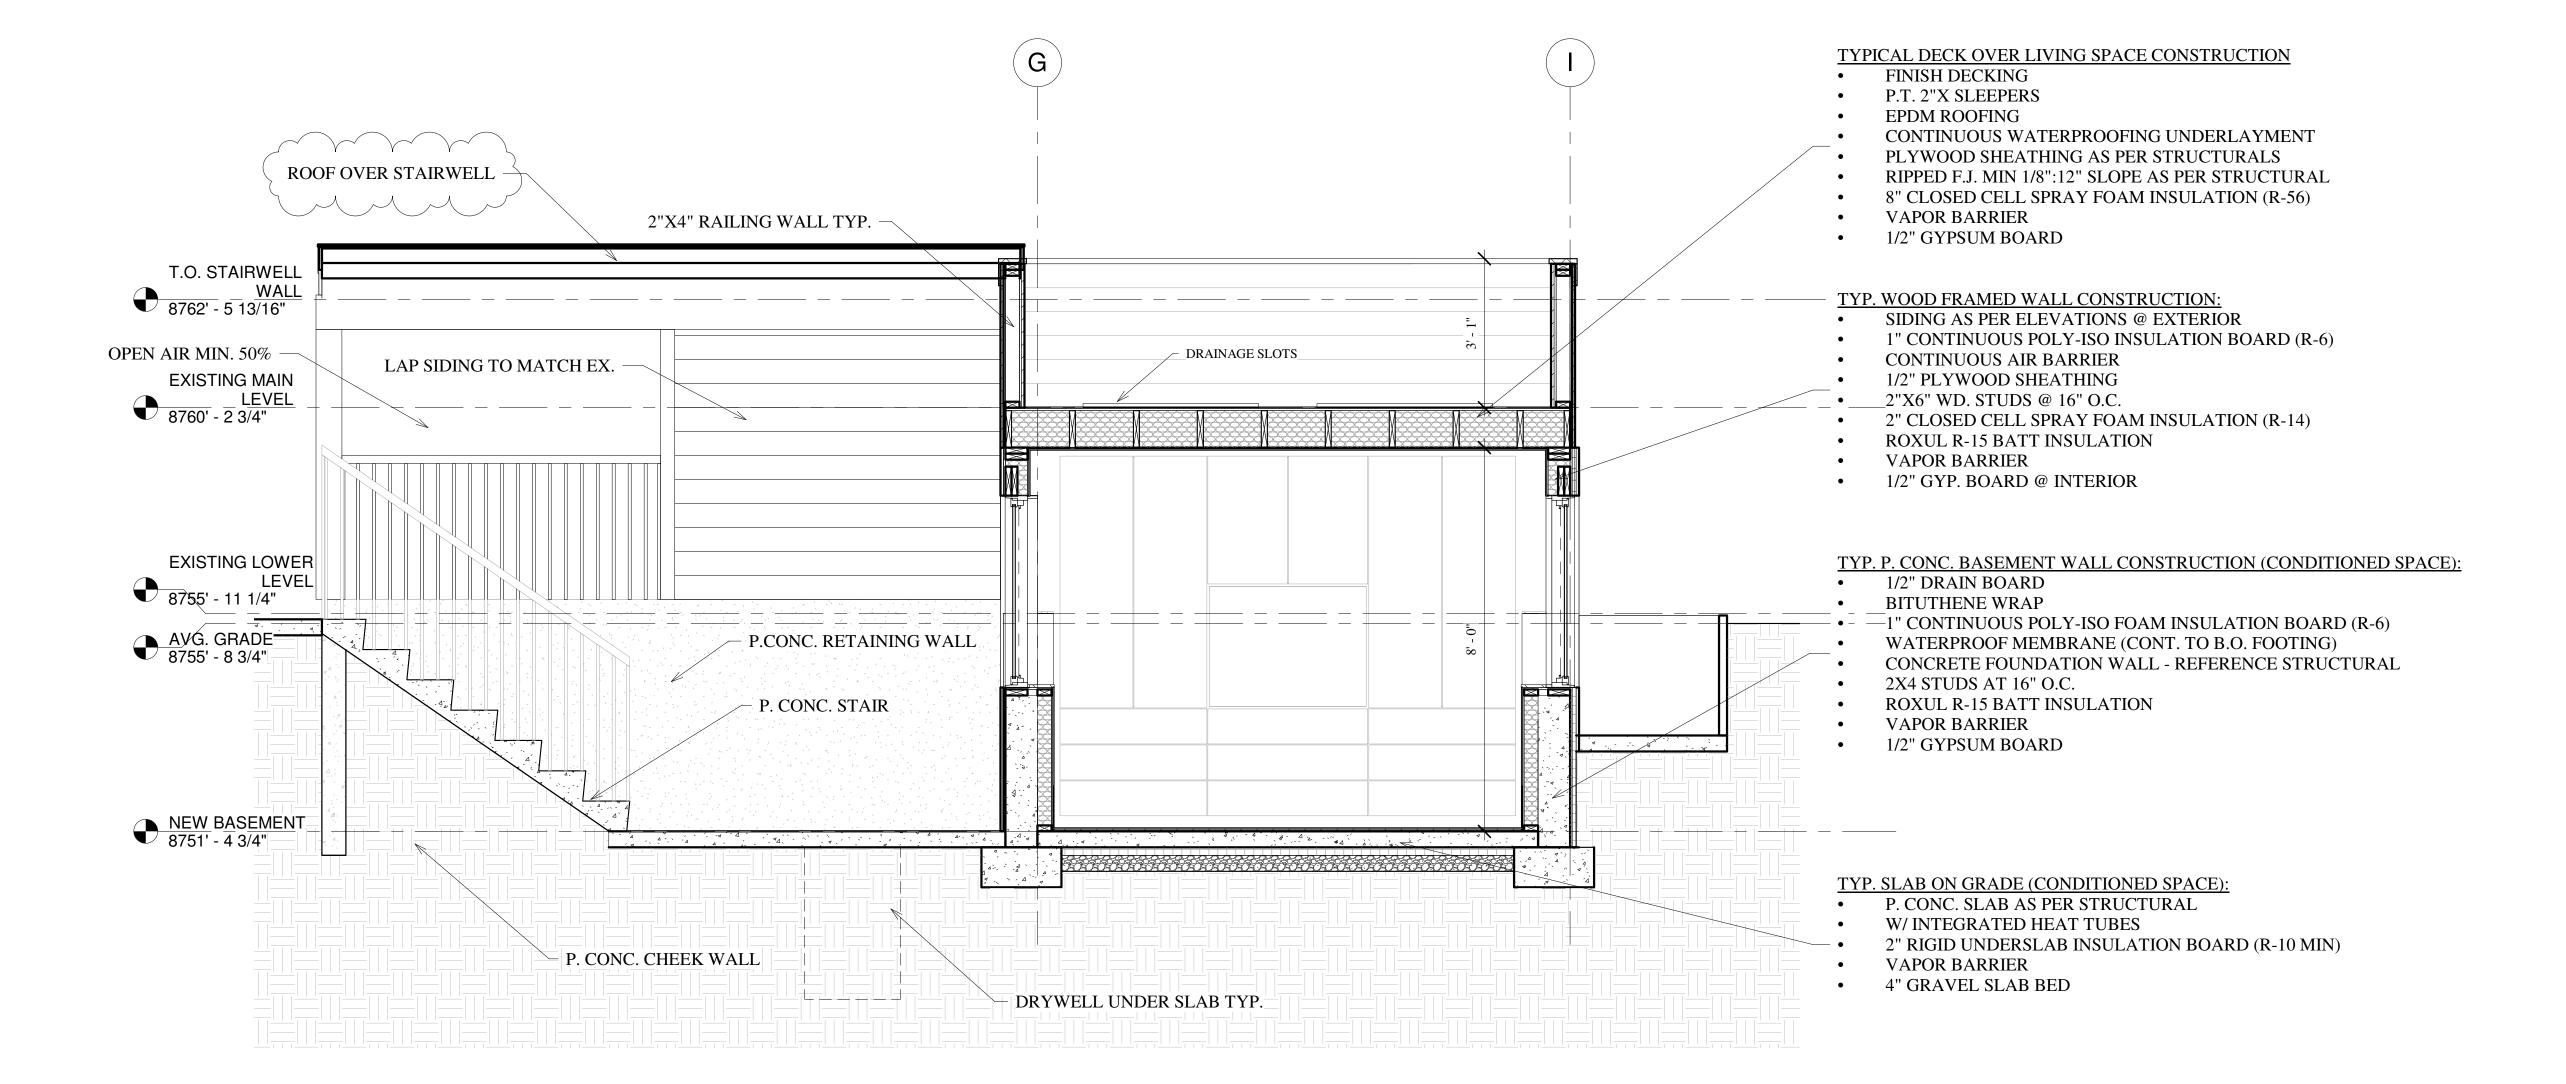






2 INTERIOR PARTITION DETAIL 1" = 1'-0"

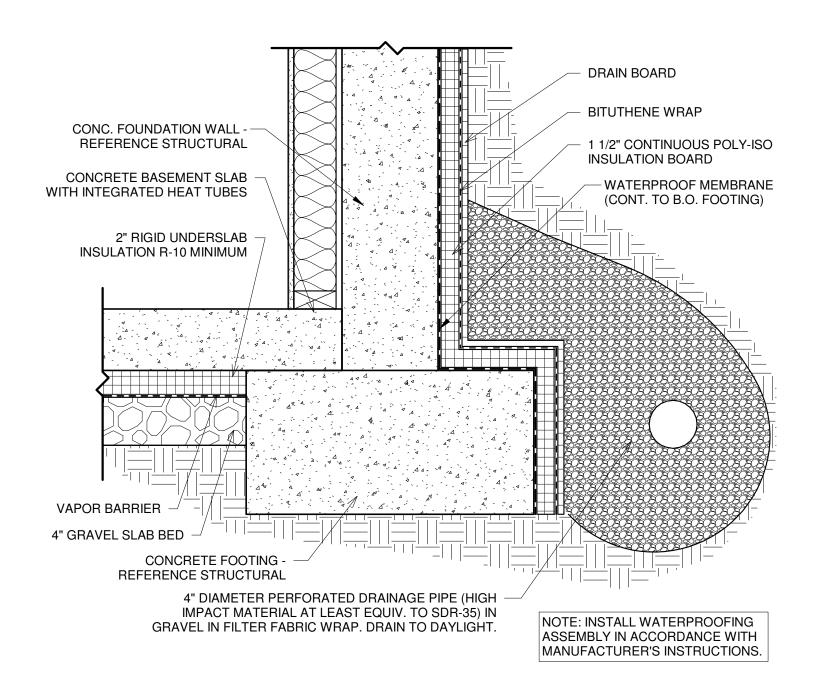

7 CONCRETE FOOTING DETAIL 1 1/2" = 1'-0"

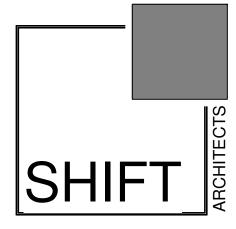

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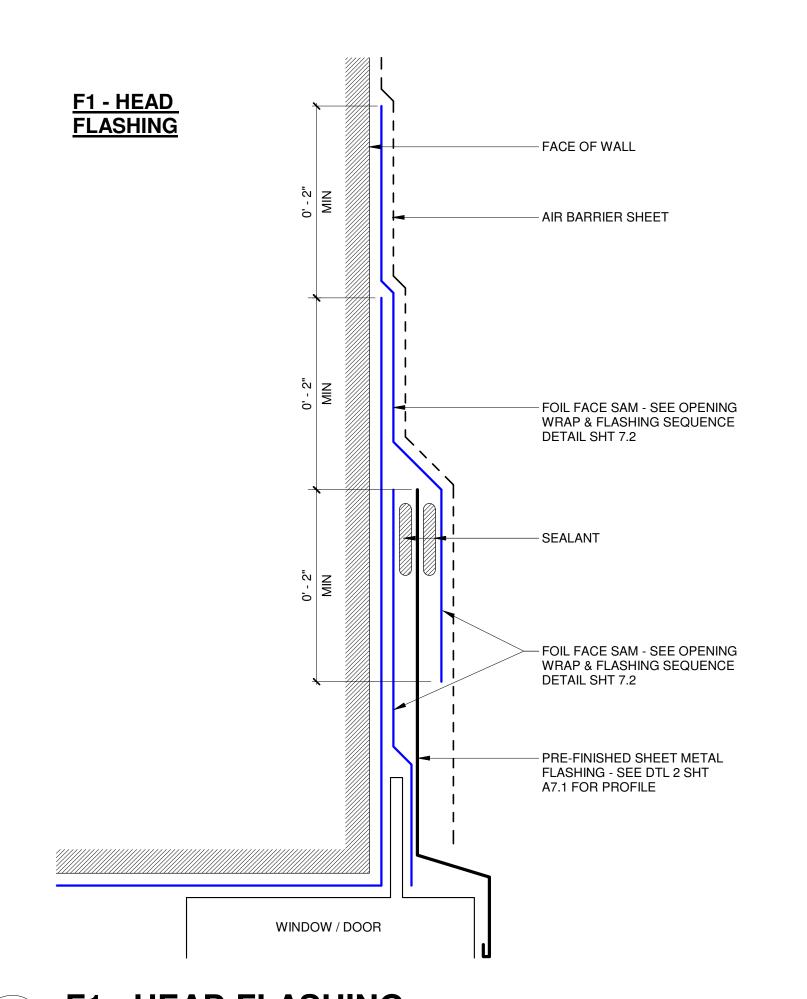
DATE: REVISED HOA SET 07.07.22


MALLETTE RESIDENCE


WALL DETAILS


SHEET NUMBER

4:36:24 PM




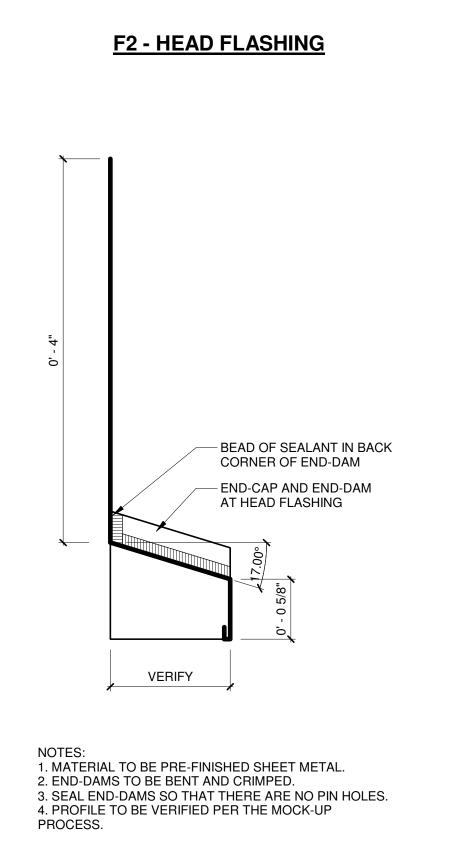


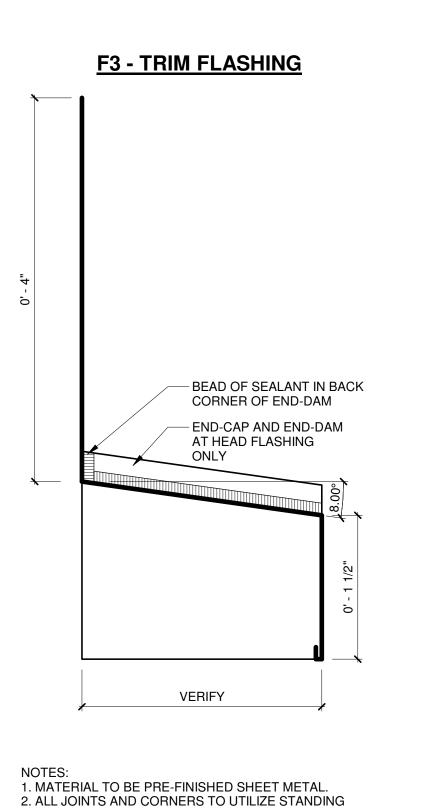

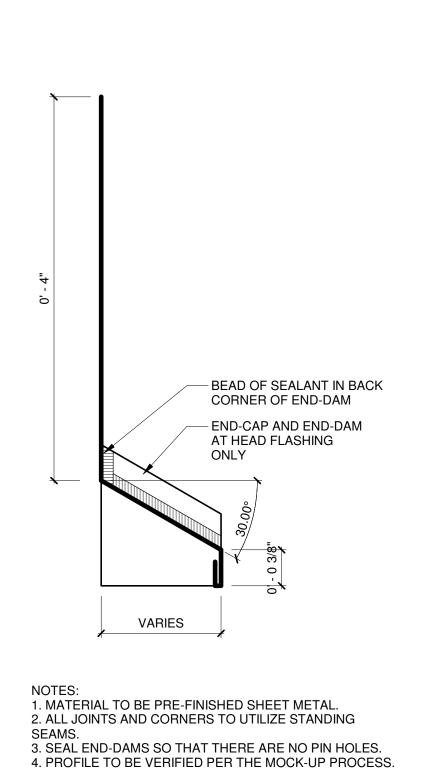

F4 - THRU-WALL FLASHING

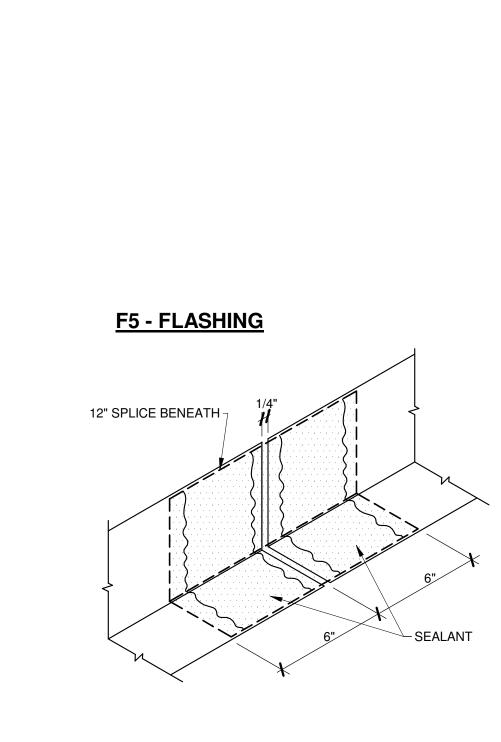

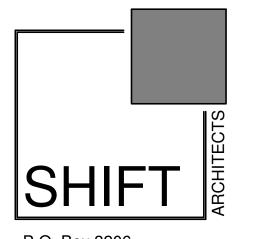

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REVISION

NO. DATE DESC.

1 F1 - HEAD FLASHING

2 F2 - FLASHING PROFILE


3 F3 - FLASHING PROFILE

3. SEAL END-DAMS SO THAT THERE ARE NO PIN HOLES.

4. PROFILE TO BE VERIFIED PER THE MOCK-UP PROCESS.

4 F4 - FLASHING PROFILE


5 TYP LAP JOINT AT FLASHING

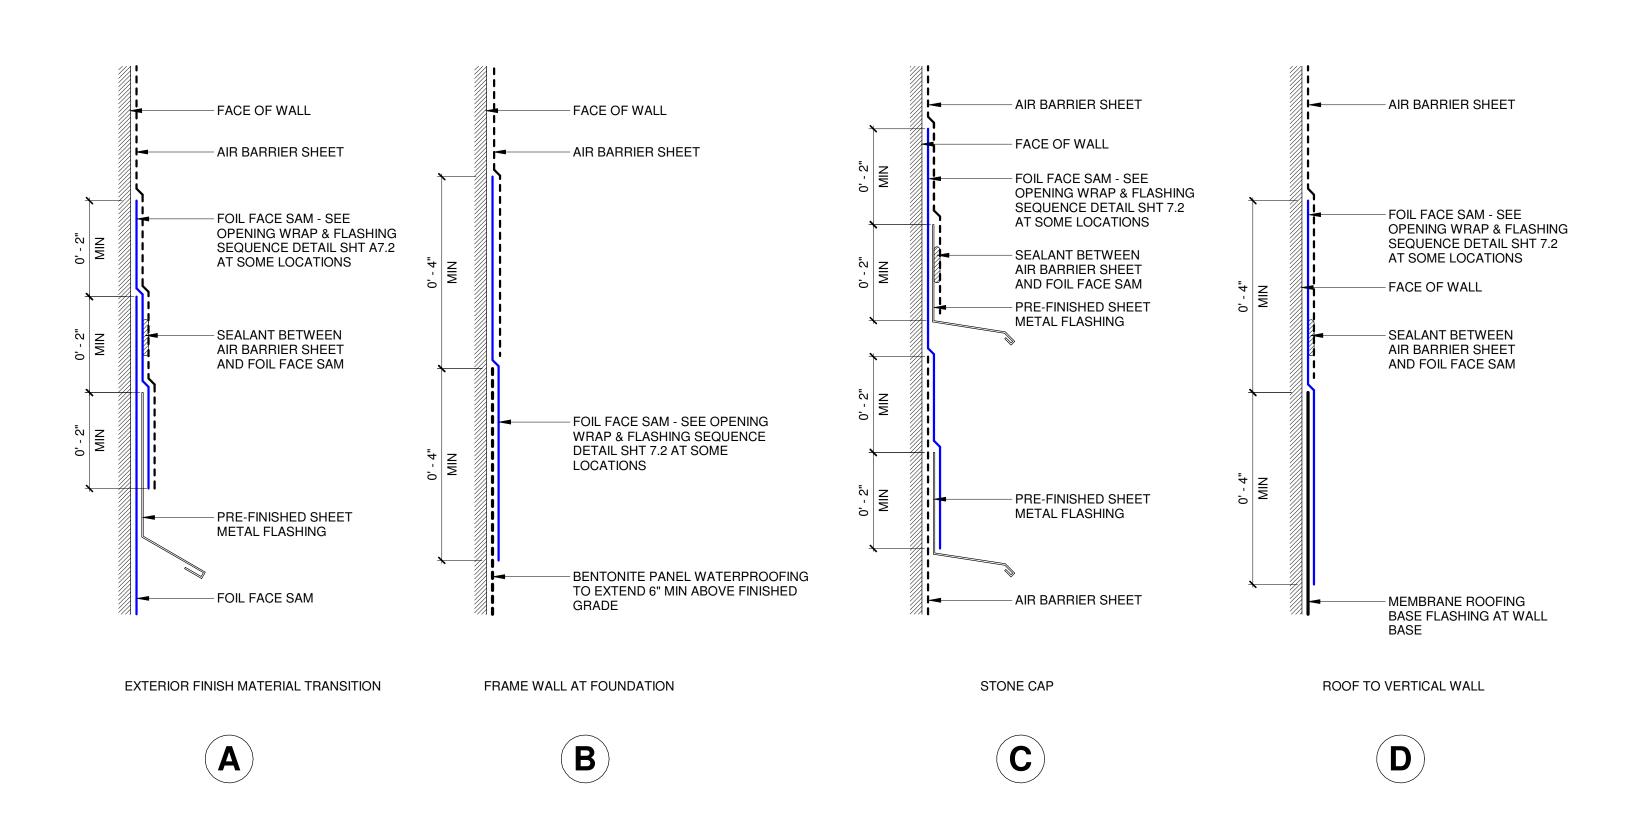



MALLETTE RESIDENCE


FLASHING DETAILS

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STEP 4

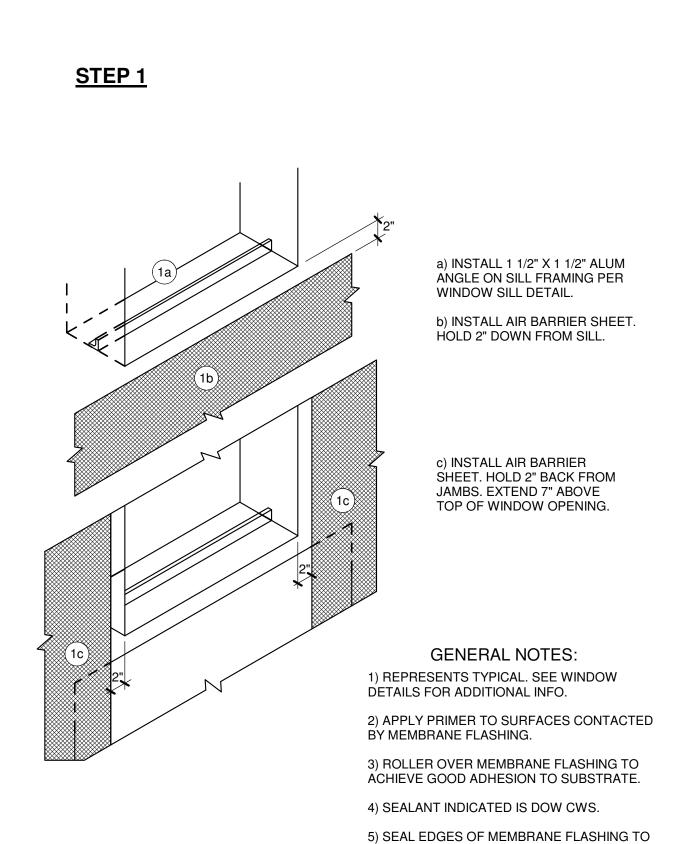EXTEND BEYOND INTERIOR SEALANT JOINT a) INSTALL 12-INCH WIDE MEMBRANE FLASHING AT JAMBS. EXTEND 3" ABOVE HEAD, CUT AND FOLD INWARD AND ONTO UNDERSIDE OF HEADER AS SHOWN. b) HOLD UP 3" FROM SILL AT JAMB AS SHOWN. c) INSTALL 12-INCH WIDE MEMBRANE FLASHING AT HEAD. EXTEND 8" BEYOND EACH JAMB, CUT AND FOLD INWARD AND ONTO UNDERSIDE OF

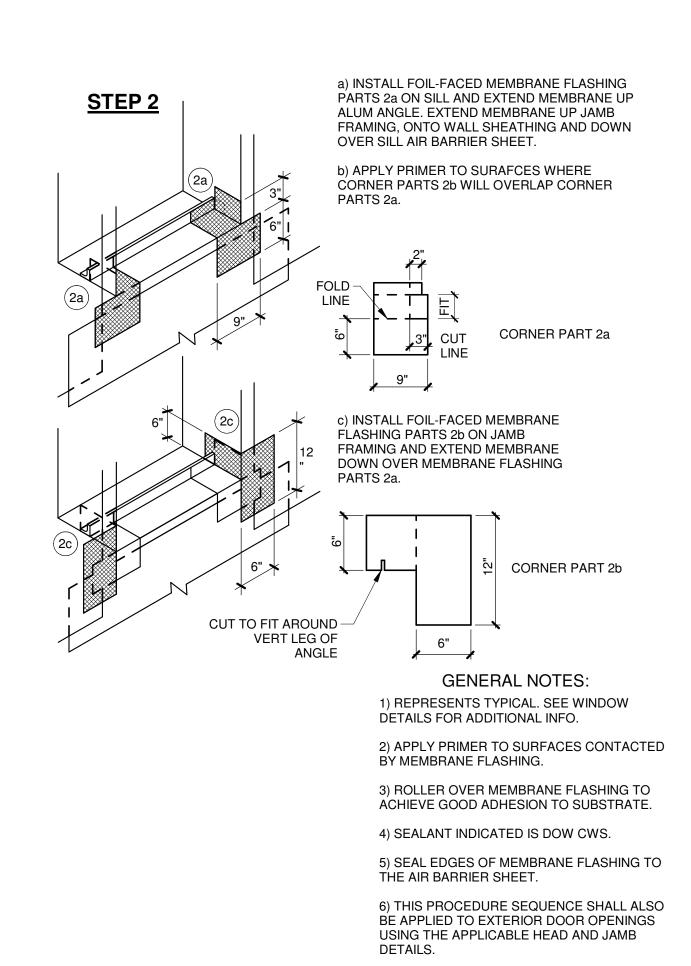HEADER AS SHOWN. **GENERAL NOTES:** 1) REPRESENTS TYPICAL. SEE WINDOW DETAILS FOR ADDITIONAL INFO. 2) APPLY PRIMER TO SURFACES CONTACTED BY MEMBRANE FLASHING. 3) ROLLER OVER MEMBRANE FLASHING TO ACHIEVE GOOD ADHESION TO SUBSTRATE. 4) SEALANT INDICATED IS DOW CWS.

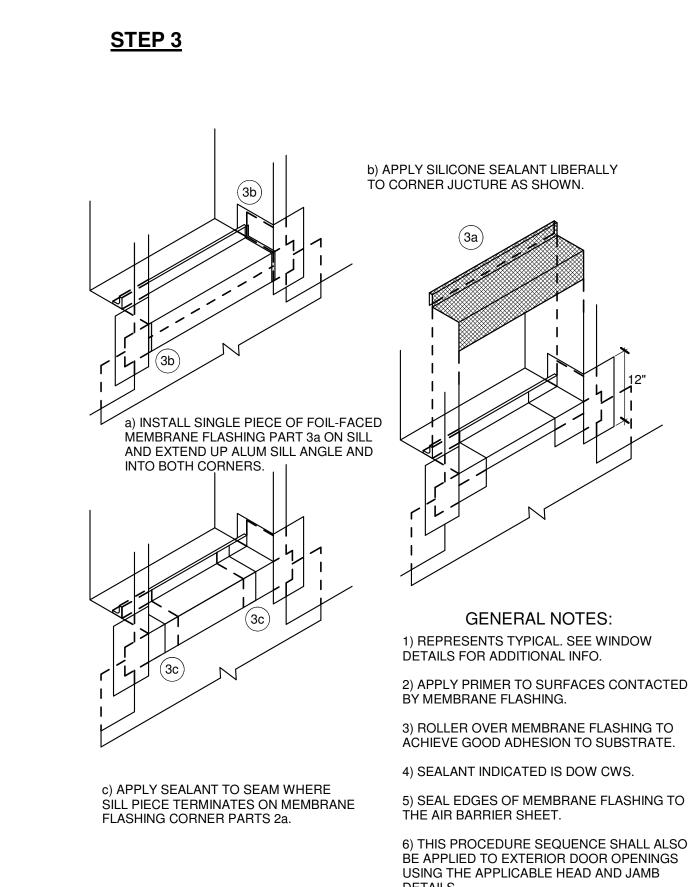THE AIR BARRIER SHEET. 6) THIS PROCEDURE SEQUENCE SHALL ALSO BE APPLIED TO EXTERIOR DOOR OPENINGS USING THE APPLICABLE HEAD AND JAMB DETAILS.

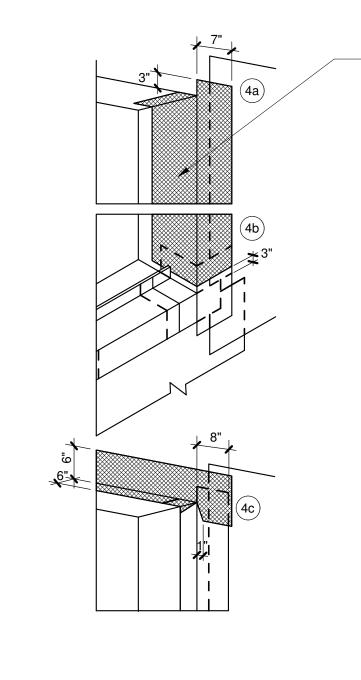5) SEAL EDGES OF MEMBRANE FLASHING TO

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REVISION

NO. DATE DESC.

DETAILS.

THE AIR BARRIER SHEET.

6) THIS PROCEDURE SEQUENCE SHALL ALSO

BE APPLIED TO EXTERIOR DOOR OPENINGS


USING THE APPLICABLE HEAD AND JAMB


OPENING WRAP / FLASHING SEQUENCE OPENING WRAP / FLASHING SEQUENCE OPENING WRAP / FLASHING SEQUENCE OPENING WRAP / FLASHING SEQUENCE






STEP 7

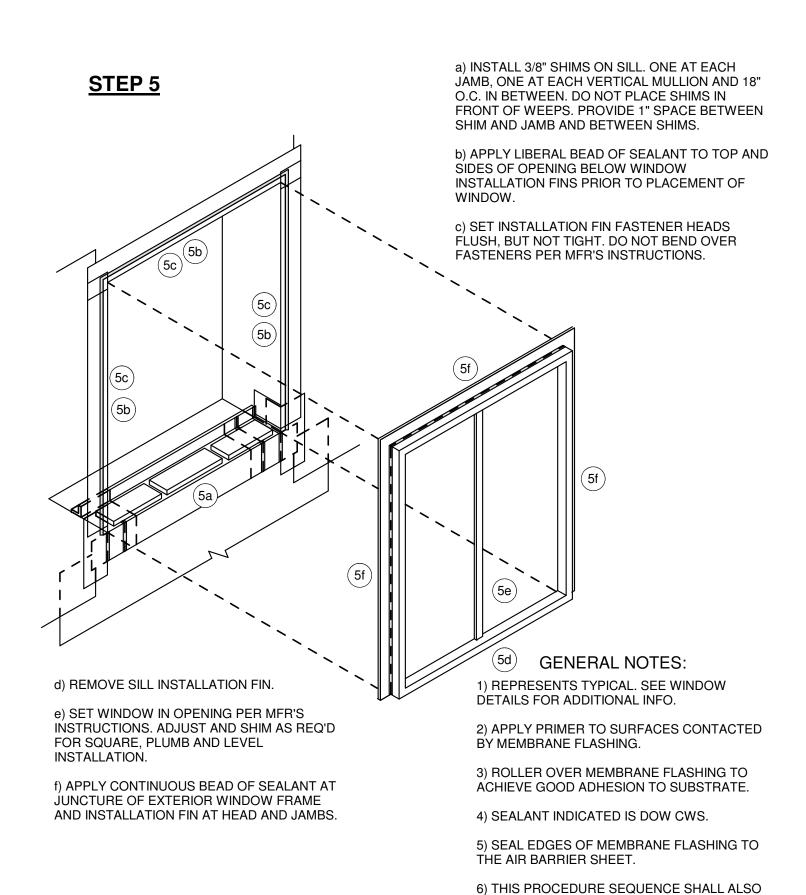

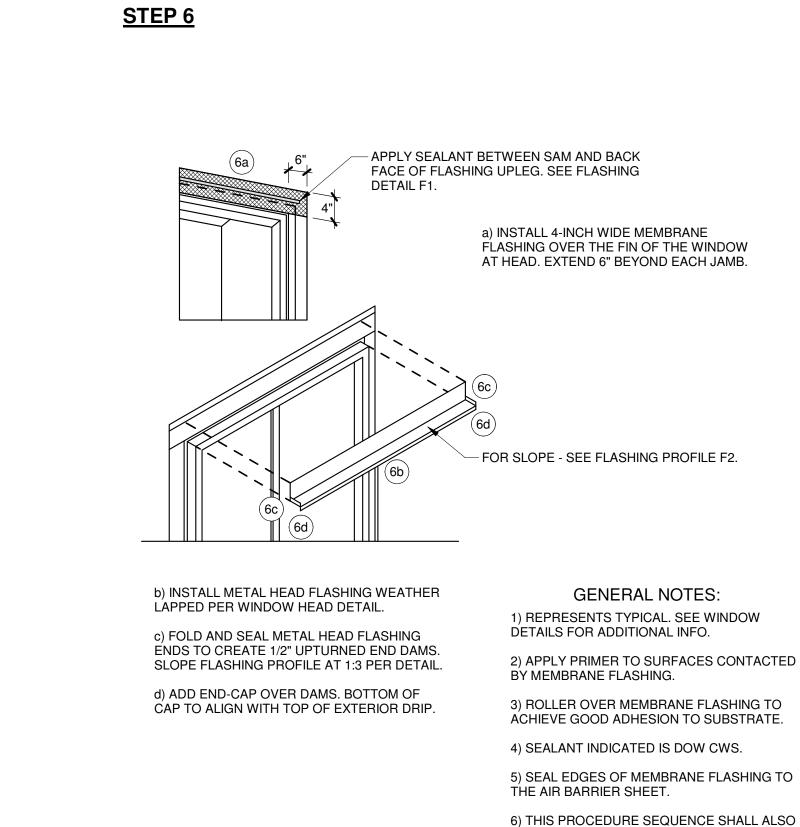

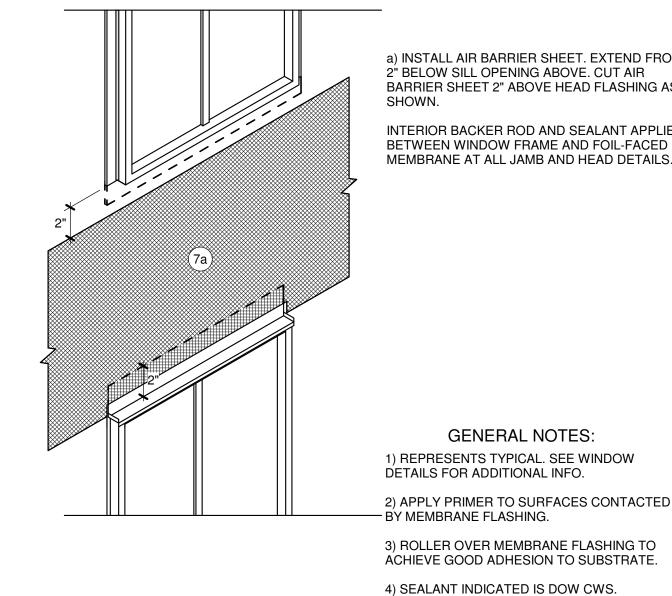

a) INSTALL AIR BARRIER SHEET. EXTEND FROM 2" BELOW SILL OPENING ABOVE. CUT AIR BARRIER SHEET 2" ABOVE HEAD FLASHING AS

INTERIOR BACKER ROD AND SEALANT APPLIED BETWEEN WINDOW FRAME AND FOIL-FACED MEMBRANE AT ALL JAMB AND HEAD DETAILS.

GENERAL NOTES:

5) SEAL EDGES OF MEMBRANE FLASHING TO

6) THIS PROCEDURE SEQUENCE SHALL ALSO

BE APPLIED TO EXTERIOR DOOR OPENINGS

USING THE APPLICABLE HEAD AND JAMB

THE AIR BARRIER SHEET.

DETAILS.

FLASHING DETAILS

SHEET NUMBER

OPENING WRAP / FLASHING SEQUENCE

OPENING WRAP / FLASHING SEQUENCE


DETAILS.


BE APPLIED TO EXTERIOR DOOR OPENINGS USING THE APPLICABLE HEAD AND JAMB

OPENING WRAP / FLASHING SEQUENCE


BE APPLIED TO EXTERIOR DOOR OPENINGS


USING THE APPLICABLE HEAD AND JAMB

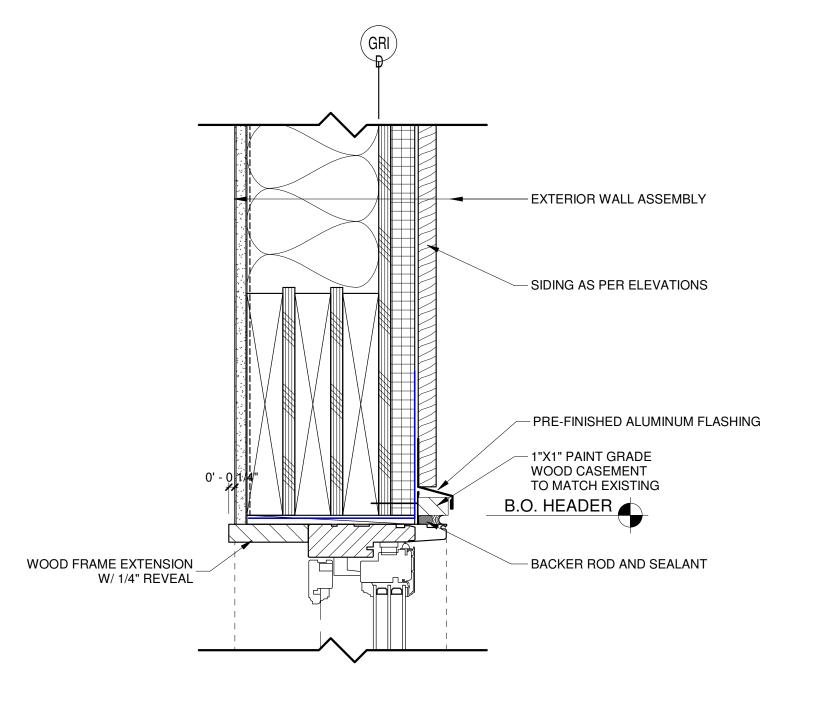


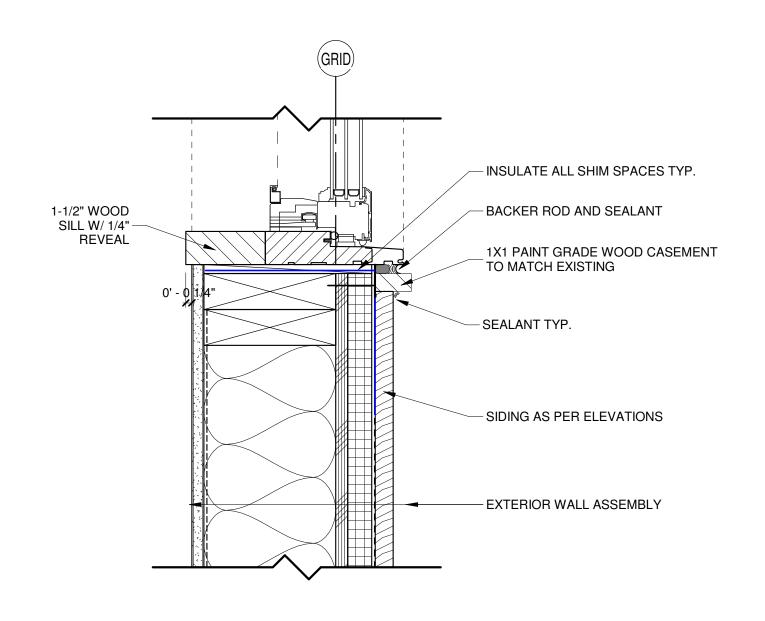

WINDOW SILL @ SIDING

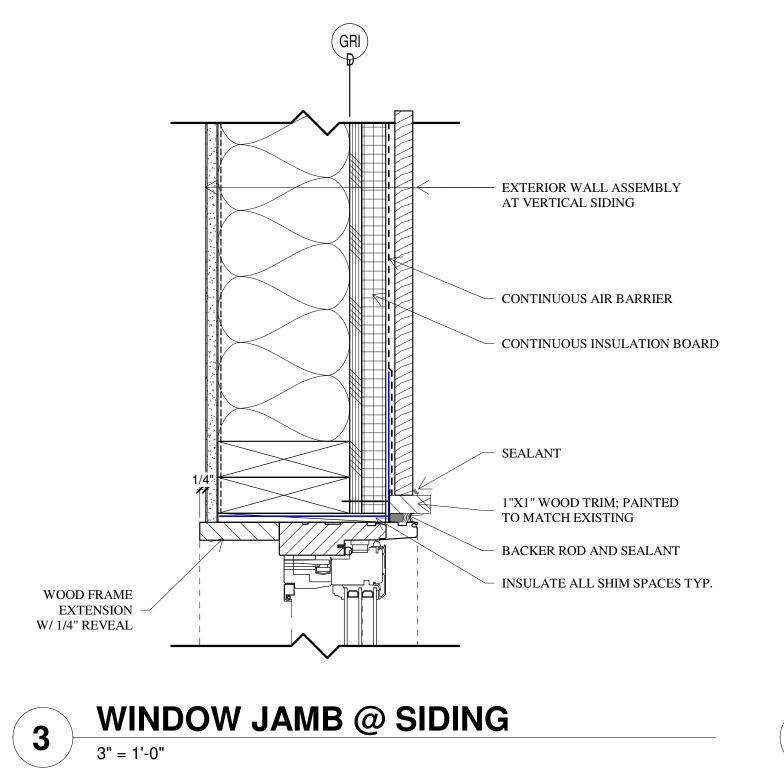

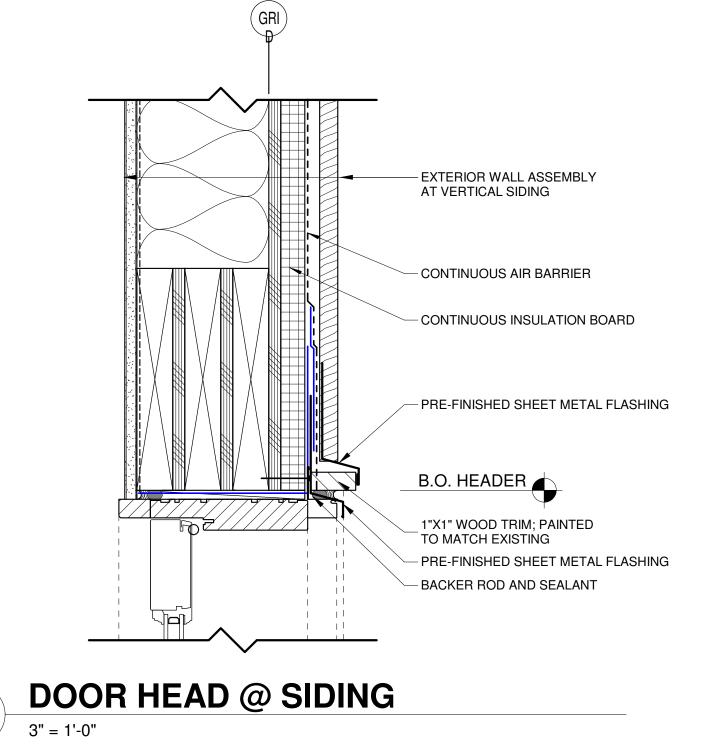

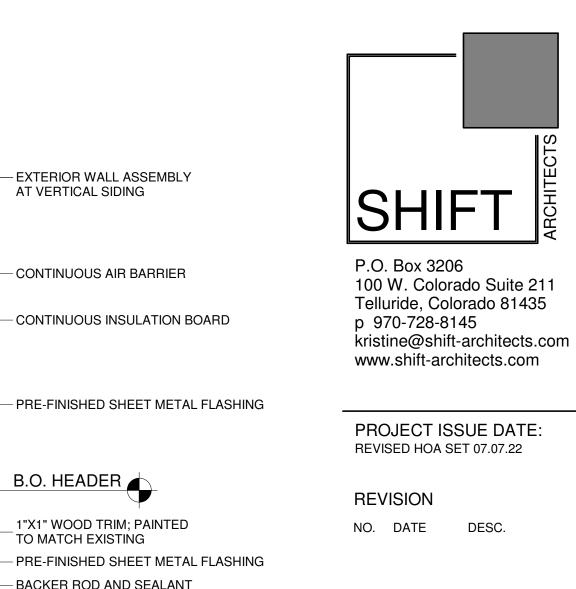

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REVISION

NO. DATE DESC.


WINDOW HEAD @ SIDING
3" = 1'-0"

— EXTERIOR WALL ASSEMBLY — SIDING AS PER ELEVATIONS - CONTINUOUS INSULATION BOARD 1"X1" PAINT GRADE — WOOD CASEMENT TO MATCH EXISTING WOOD JAMB EXTENSION — W/ 1/4" REVEAL — BACKER ROD AND SEALANT


- INSULATE ALL SHIM SPACES TYP.


5 DOOR JAMB @ SIDING
3" = 1'-0"

WINDOW / DOOR DETAILS

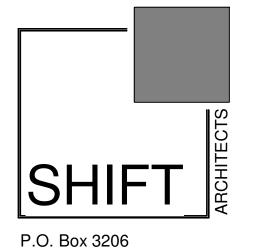

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6 INTERIOR DOOR JAMB DETAIL 3" = 1'-0"

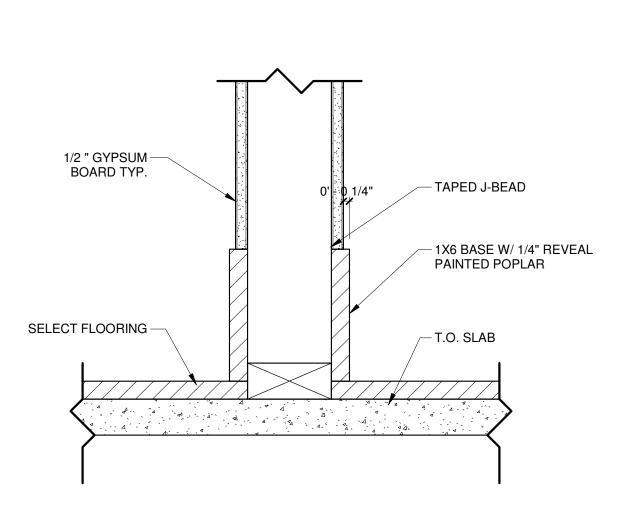- 1X8 RECESSED BASE BOARD

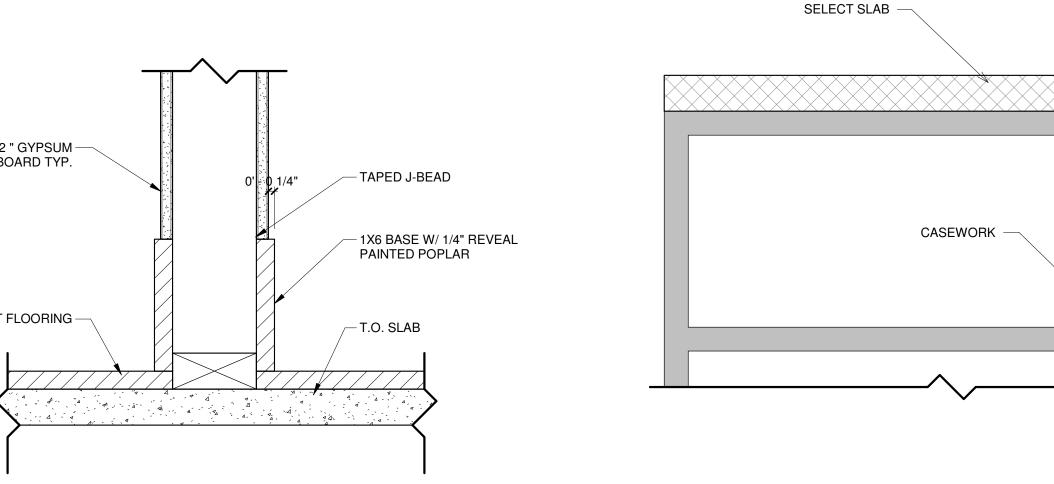W/ 1/4" REVEAL

DOOR JAMB W/ 1/4
REVEAL BOTH SIDES

1/2 " GYPSUM — BOARD TYP.


TAPED J-BEAD —

7 WOOD BASEBOARD DETAIL
3" = 1'-0"

8 SLAB EDGE DETAIL 3" = 1'-0"

EASED EDGE

7/8" OVERHANG

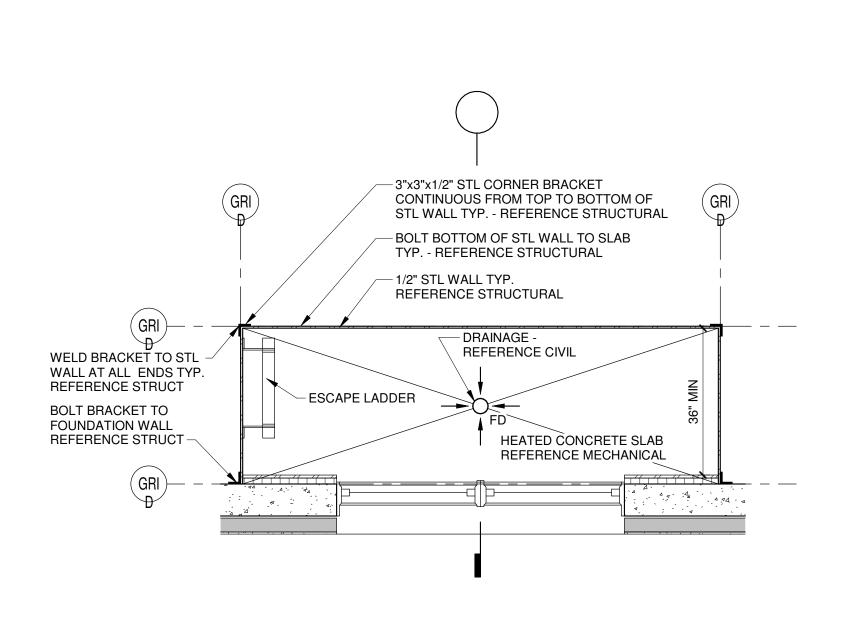

- SELECT SIDING - REFERENCE EXTERIOR ELEVATIONS

- CONTINUOUS INSULATION BOARD

- CONTINUOUS AIR BARRIER

1X4 WOOD — CORNER BOARD;

#15 FELT SPLINE OR -


INSULATE ALL – CAVITIES TYP.


5 CORNER BOARD @ WOOD SIDING
3" = 1'-0"

9 WINDOW WELL DETAIL 1/2" = 1'-0"

MEMBRANE MIN 6" PAST CORNER BOARD TYP.

MITERED 🛧

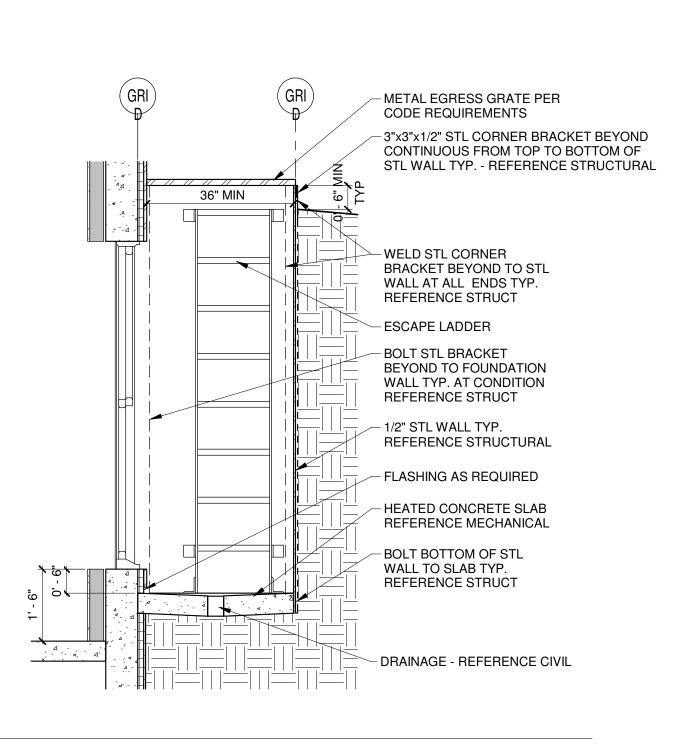

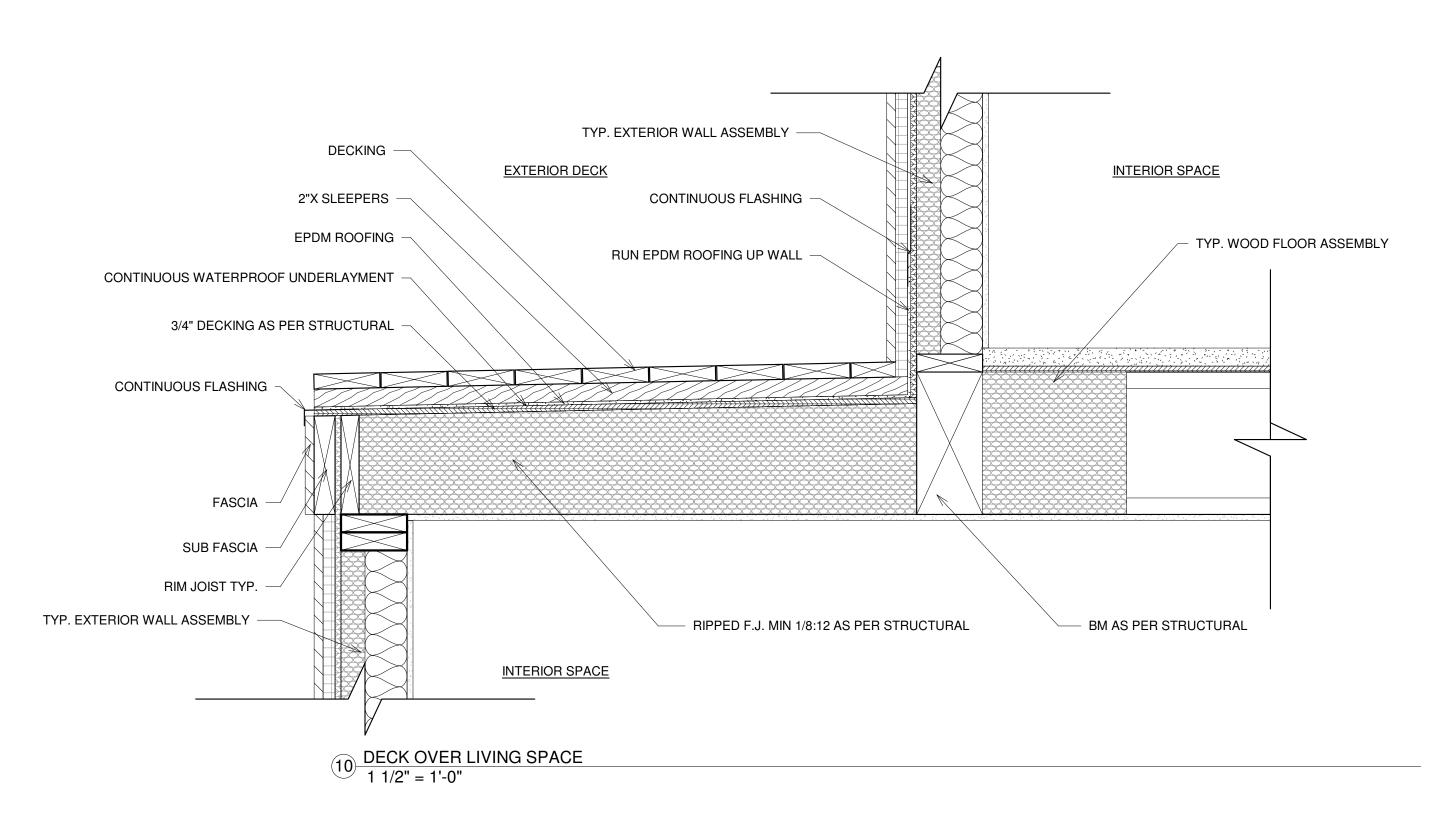

DETAILS

A7.5

ELECTRICAL WIRE

EXPANDING FOAM SEALANT

TOP PLATE

~WALL STUD

ELECTRICAL PENETRATION DETAIL

1 1/2" = 1'-0"

1 1/2" = 1'-0"

PLUMBING PIPE

EXPANDING FOAM

TOP PLATE

SEALANT


STUD WALL


PLUMBING PENETRATION DETAIL

SEALING DETAILS





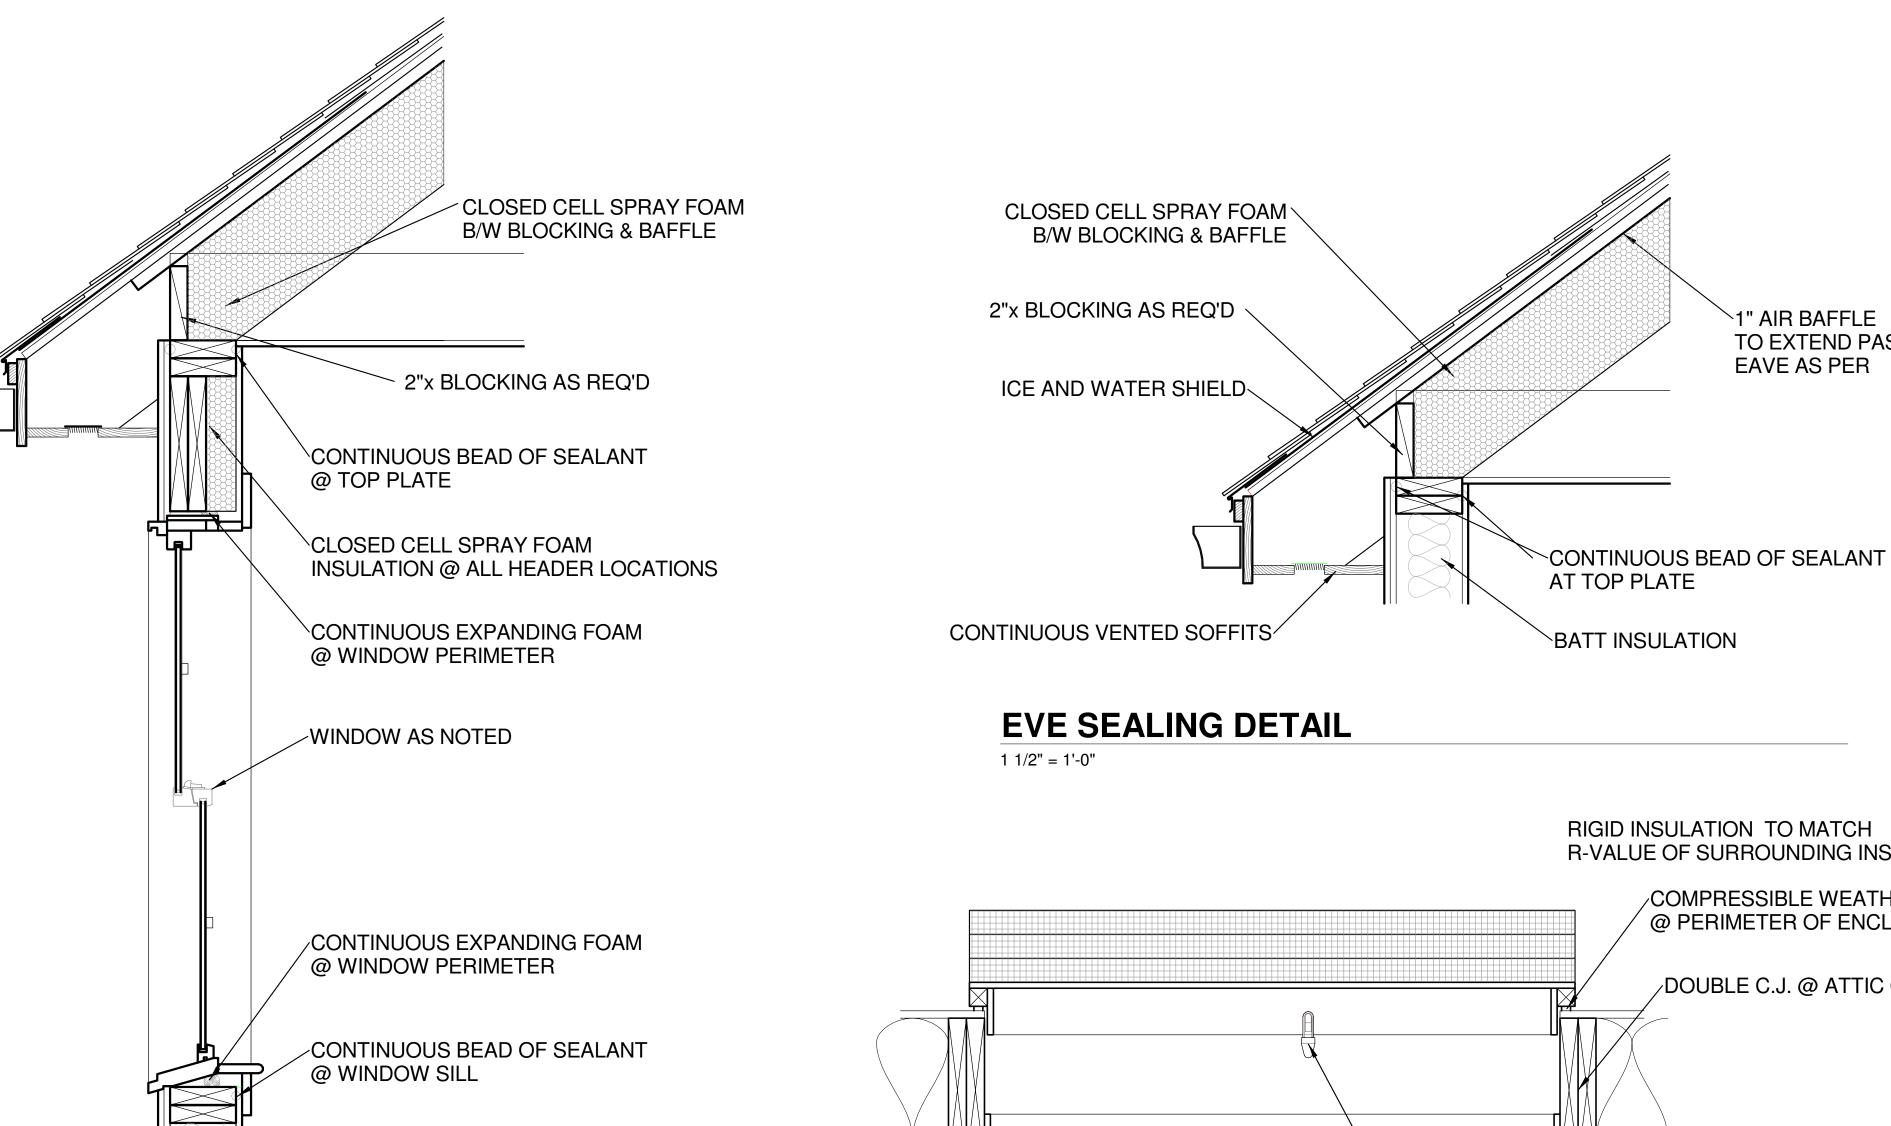


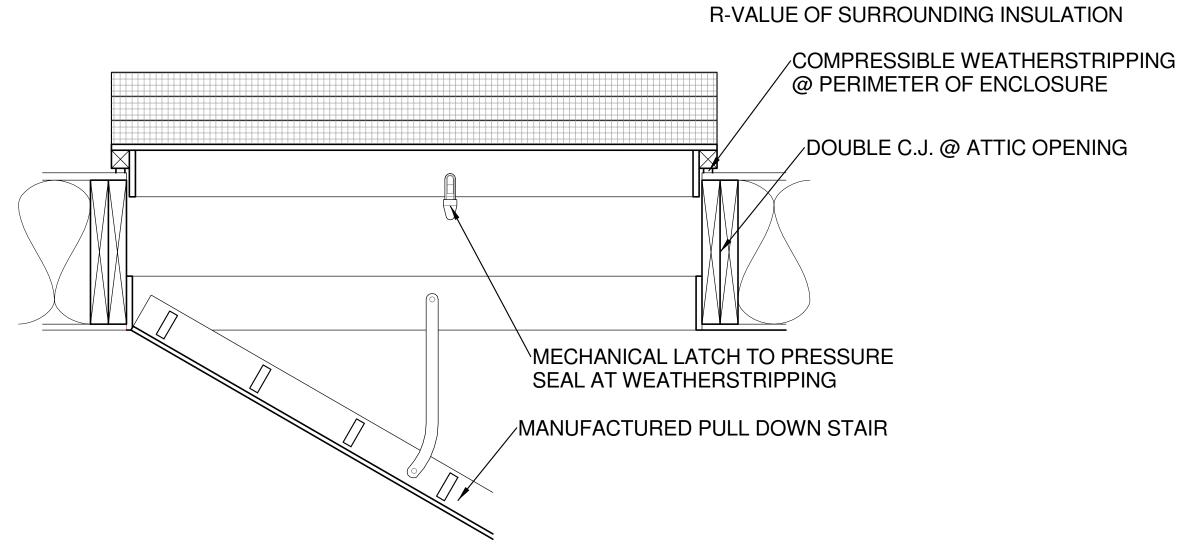


1" AIR BAFFLE

EAVE AS PER

TO EXTEND PAST

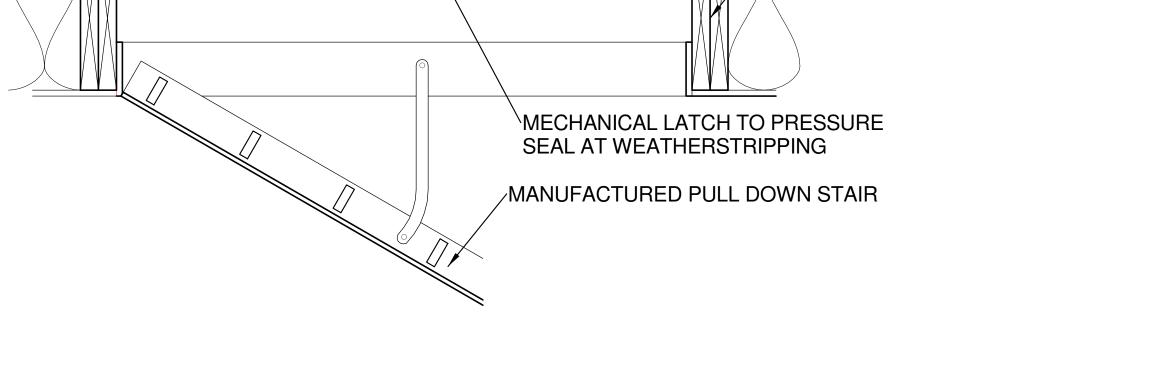



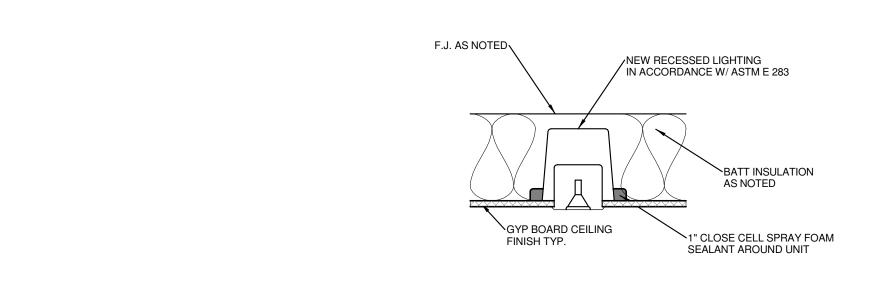

RECESSED LIGHTING SEALING DETAIL

CORNER INSULATIN DETAIL 1 1/2" = 1'-0"

EXTERIOR SHEATHING

√1/2" GYP. BOARD

(2) LAYERS 2" RIGID INSULATION

INSULATED EXTERIOR WALL

INSTALLED DURING FRAMING

CONTINUOUS BEAD OF SEALANT


@ BOTTOM PLATE

WALL / WINDOW SEALING DETAIL


1 1/2" = 1'-0"


1 1/2" = 1'-0"


			WINDOW S	CHEDULE			
Family	Туре	Mark	Width	Height	Sill Height	STYLE	Comments
CASEMENT	2-6 X 4-0	A01	2' - 6"	4' - 0"	3' - 2 3/4"	В	MATCH DOOR HDR. HEIGHT / EGRESS
CASEMENT	2-6 X 4-0	A02	2' - 6"	4' - 0"	3' - 0"	В	
CASEMENT	2-6 X 4-0	A03	2' - 6"	4' - 0"	3' - 0"	Α	EGRESS
CASEMENT	2-6 X 4-0	A04	2' - 6"	4' - 0"	3' - 0"	Α	EGRESS
CASEMENT	2-6 X 4-0	A05	2' - 6"	4' - 0"	3' - 0"	Α	EGRESS
CASEMENT	2-6 X 4-0	A06	2' - 6"	4' - 0"	3' - 0"	Α	EGRESS
AWNING	2-6 X 3-0	B01	2' - 6"	3' - 0"	4' - 6"	D	
AWNING	2-6 X 3-0	B02	2' - 6"	3' - 0"	4' - 6"	D	
CASEMENT	2-6 X 4-0	B03	2' - 6"	4' - 0"	3' - 0"	В	EGRESS
CASEMENT	2-6 X 4-0	B04	2' - 6"	4' - 0"	3' - 0"	В	EGRESS
CASEMENT	2-0 X 4-0	B05	2' - 0"	4' - 0"	3' - 0"	Е	
FIXED	3-0 X 4-6	B06	3' - 0"	4' - 6"	3' - 0"	F	
CASEMENT	2-6 X 3-6	C01	2' - 6"	3' - 6"	4' - 0"	С	
CASEMENT	2-0 X 4-6	C02	2' - 0"	4' - 6"	2' - 6"	G	
FIXED	3-0 X 4-6	C03	3' - 0"	4' - 6"	2' - 6"	G	
CASEMENT	2-0 X 4-6	C04	2' - 0"	4' - 6"	2' - 6"	G	
CASEMENT	2-0 X 4-6	C05	2' - 0"	4' - 6"	2' - 6"	G	
FIXED	3-0 X 4-6	C06	3' - 0"	4' - 6"	2' - 6"	G	
CASEMENT	2-0 X 4-6	C07	2' - 0"	4' - 6"	2' - 6"	G	
FIXED	3-0 X 4-6	C08	3' - 0"	4' - 6"	3' - 0"	F	
CASEMENT	2-0 X 4-6	C09	2' - 0"	4' - 6"	3' - 0"	Н	
CASEMENT	2-0 X 4-6	C10	2' - 0"	4' - 6"	3' - 0"	Н	
FIXED	3-0 X 4-6	C11	3' - 0"	4' - 6"	3' - 0"	F	
CASEMENT	2-6 X 4-0	C12	2' - 6"	4' - 0"	3' - 2"	В	

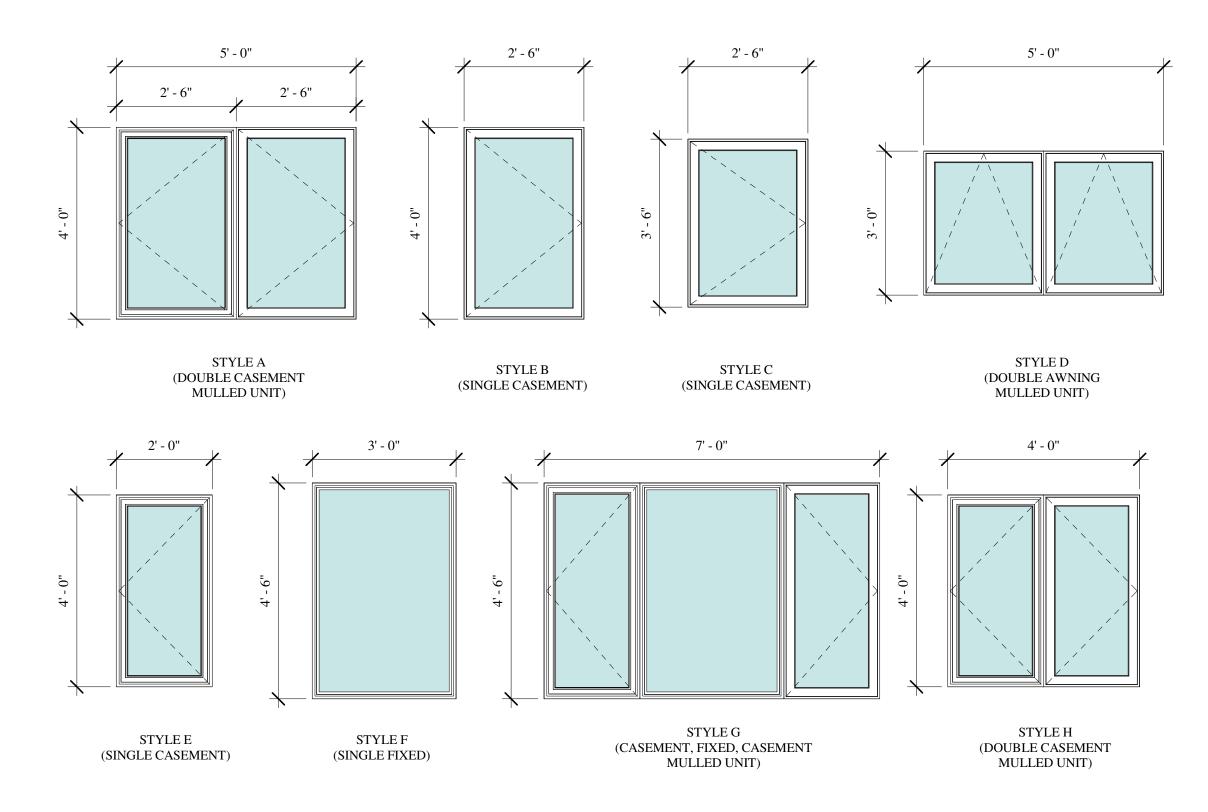

DOOR SCHEDULE									
Family	Туре	Mark	Width	Height	Style	Comments			
SINGLE GLASS INSWING	3-0 X 7-0	001	3' - 1 7/16"	7' - 2"	D	2/3 LIGHT / SAFETY GLASS			
SINGLE FLUSH	2-8 X 6-8	002	2' - 8"	6' - 8"	Α				
POCKET DOOR	2-4 X 6-8	003	2' - 4"	6' - 8"	В				
SINGLE FLUSH	2-8 X 6-8	004	2' - 8"	6' - 8"	Α				
SINGLE FLUSH	2-0 X 6-8	005	2' - 0"	6' - 8"	Α				
SINGLE FLUSH	2-6 X 6-8	006	2' - 6"	6' - 8"	Α				
SINGLE FLUSH	2-6 X 6-8	007	2' - 6"	6' - 8"					
SINGLE FLUSH	2-8 X 6-8	101	2' - 8"	6' - 8"	Α				
SINGLE FLUSH	2-0 X 6-8	102	2' - 0"	6' - 8"	Α				
SINGLE FLUSH	2-8 X 6-8	103	2' - 8"	6' - 8"	Α				
SINGLE FLUSH	2-4 X 6-8	104	2' - 4"	6' - 8"	Α				
SINGLE FLUSH	2-4 X 6-8	105	2' - 4"	6' - 8"	Α				
SINGLE FLUSH	2-4 X 6-8	106	2' - 4"	6' - 8"	Α				
SINGLE GLASS OUTSWING	3-0 X 7-0	107	3' - 1 7/16"	7' - 2"	D	2/3 LIGHT / SAFETY GLASS			
3 PANEL SLIDING GLASS	9-0 X 7-0	201	9' - 2 3/4"	7' - 2"	С	2/3 LIGHT / SAFETY GLASS			

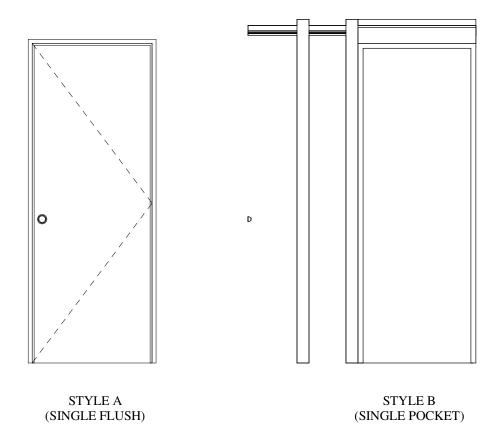

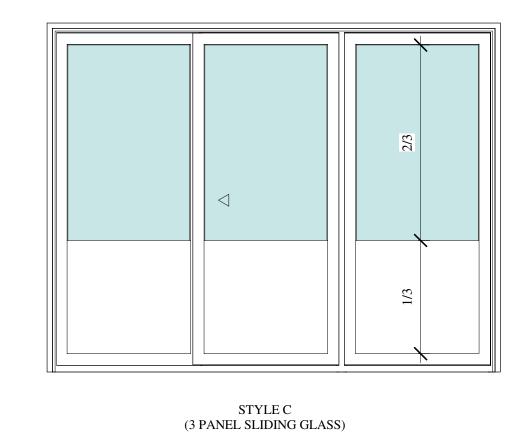

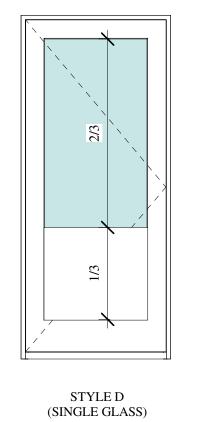

DATE: REVISED HOA SET 07.07.22

RESIDENCE

DOOR / WINDOW SCHEDULE

			PLU	JMBING SCH	HEDULE		
ROOM #	ROOM NAME	COUNT	TYPE	MANUFACTUR	MODEL	FINISH	COMMENTS
003	FULL BATH	1	FAUCET	KOHLER	K-14402-4A-BN	BRUSHED	
		1	SINK	KOHLER	Ladena K-2215-0	WHITE	INSTALLATION-UNDERMOUNT
		1	TOILET	TOTO; AQUIA	SKU:	#01 COTTON	
		1	SHOWER / TUB FILLER	KOHLER	K-T99763-4G-CP	BRUSHED	
		1	TOILET PAPER HOLDER	KOHLER	K-26638-CP	BRUSHED	
		3	WALL HOOKS	KOHLER	K-26636-CP	BRUSHED	
		1	TUB	KOHLER	K-847-0	WHITE	
103	KITCHEN	1	FAUCET	KOHLER	K-24982	VIBRANT	
		1	SINK	KOHLER	K-3942-3	STAINLESS	INSTALLATION-TOPMOUNT
		1	DISPOSAL	INSINKERATOR	1/2 HP	STAINLESS	COUNTERTOP SWITCH
		1	SOAP DISPENSER	KOHLER	K-1895-C-VS	VIBRANT	
202	MASTER	1	FAUCET	KOHLER	K-14406-4-G	BRUSHED	
		1	SINK	KOHLER	Ladena K-2214-0	WHITE	INSTALLATION-UNDERMOUNT
		1	TOILET	TOTO; AQUIA	SKU:	#01 COTTON	
		1	SHOWER HEAD HAND SHOWER/	KOHLER	KSS-PURIST-4-RTHS	BRUSHED	
		1	TOILET PAPER HOLDER	KOHLER	TP-14444-BN	BRUSHED	
		3	WALL HOOKS	KOHLER	TP-14443-BN	BRUSHED	

	APPLICANCE SCHEDULE									
ROOM#	ROOM NAME	COUNT	FAMILY	MANUFACTUR	MODEL	FINISH	COMMENTS			
005	LAUNDRY	1	WASHER	BOSCH	WAW285H2UC	WHITE	STACKABLE			
005	LAUNDRY	1	DRYER	BOSCH	WTG865H4UC	WHITE	STACKABLE			
202	KITCHEN	1	36" RANGE	WOLF	DF36450G/S/P	STAINLESS	DUEL FUEL			
202	KITCHEN	1	36"	SUBZERO	IT-36CI	PANEL READY				
202	KITCHEN	1	HOOD VENT	WOLF	PW362718	STAINLESS				
202	KITCHEN	1	MICROWAVE	WOLF	MDD24TE/S/TH	STAINLESS	IN CABINET			
202	KITCHEN	1	DISHWASHER	BOSCH	SHVM78Z53N	PANEL READY				
204	LIVING	1	GAS FIREPLACE	HEAT & GLO	COSMO42-IFT-B	CLEAN FACE				

SHIFT	ARCHITECTS

DATE:

REVISED HOA SET 07.07.22

					FINISH SCHEDULE					
Name	Number	FLOOR	BASE	WINDOW & DOOR TRIM	WALLS	Ceiling Finish	SHOWER FLOOR	SHOWER WALLS	BACKSPLASH	COUNTER
GUEST ROOM	001	WOOD	BASE # 1	TRIM # 1	PAINTED SKIP TROWEL	PAINTED SKIP TROWEL				
MUDROOM	002	WOOD	BASE # 1	TRIM # 1	PAINTED SKIP TROWEL	PAINTED SKIP TROWEL				
FULL BATH	003	TILE # 3	BASE # 1	TRIM # 1	PAINTED SKIP TROWEL	PAINTED SKIP TROWEL	TILE # 3 4X4	TILE # 2		SLAB # 1
BEDROOM	004	WOOD	BASE # 1	TRIM # 1	PAINTED SKIP TROWEL	PAINTED SKIP TROWEL				
LAUNDRY	005	TILE # 3	BASE # 1	TRIM # 1	PAINTED SKIP TROWEL	PAINTED SKIP TROWEL				SLAB # 1
MASTER BEDROOM	101	WOOD	BASE # 1	TRIM # 1	PAINTED SKIP TROWEL	PAINTED SKIP TROWEL				
MASTER CL.	102	WOOD	BASE # 1	TRIM # 1	PAINTED SKIP TROWEL	PAINTED SKIP TROWEL				
MASTER BATH	103	TILE # 5	BASE # 1	TRIM # 1	TILE # 7	PAINTED SKIP TROWEL	TILE # 5 4X4	TILE # 7		SLAB#1
OFFICE	104	WOOD	BASE # 1	TRIM # 1	PAINTED SKIP TROWEL	PAINTED SKIP TROWEL				
LOWER FOYER	105	WOOD	BASE # 1	TRIM # 1	PAINTED SKIP TROWEL	PAINTED SKIP TROWEL				
FOYER	201	WOOD	BASE # 1	TRIM # 1	PAINTED SKIP TROWEL	PAINTED SKIP TROWEL				
KITCHEN	202	WOOD	BASE # 1	TRIM # 1	PAINTED SKIP TROWEL	PAINTED SKIP TROWEL			TILE # 4	SLAB#1
DINING	203	WOOD	BASE # 1	TRIM # 1	PAINTED SKIP TROWEL	PAINTED SKIP TROWEL				
LIVING	204	WOOD	BASE # 1	TRIM # 1	PAINTED SKIP TROWEL	PAINTED SKIP TROWEL				
ENTRY	205	WOOD	BASE # 1	TRIM # 1	PAINTED SKIP TROWEL	PAINTED SKIP TROWEL				

CABINETS:

KITCHEN CABINETS:

-WOOD; RIFTED WHITE OAK, LIGHT WIRE -FLAT PANEL; ANTIQUED GRAY OAK FINISH

BATHS / MUDROOM:

-WOOD; RIFTED WHITE OAK, LIGHT WIRE

-FLAT PANEL; NATURAL FINISH

WOOD:

SIZE: 6" WIDE; RANDOM LENGTH

WOOD: WHITE OAK; RUSTIC

COLOR: MATTE FINISH

TILES:

TILE #1: DECORATIVE MATERIAL; BLACK BASALT ANTIQUED FLAMED; 12"X24"

TILE #2: DECORATIVE MATERIAL; WHITE 2"X10" CASTELLON

TILE #3: DECORATIVE MATERIAL; PORCELAIN COLLECTION; TIMEWORM' LIGHT GREY 24"X24" ITEM # PTWGRYLM24

TILE #4: DECORATIVE MATERIAL; SKYLINE HONED PAVER 4"X12"

TILE #5: DECORATIVE MATERIAL; PORCELAIN COLLECTION; TIMEWORM, DARK GREY 24"X24" ITEM # PTWGRYDM24

TILE #6: DECORATIVE MATERIAL; AKDO CARRARA 2"X8"

TILE #7: DECORATIVE MATERIAL; STUDIO MOSAIC; MONTE MSS01534 SKYLINED HONED SNOW WHITE 12"X12"

SLABS:

SLAB #1: ARIZONA TILE; DELLA TERRA QUARTZ SILVER STALLION 3CM

BASE:

BASE #1: 1"X6" POPLAR; PAINTED TO MATCH PLASTER

TRIM:

TRIM #1:

WINDOW:

EXTENDED WOOD JAMB W/ 1-1/2" WOOD SILL; 1/4" DRYWALL REVEAL, POPLAR, PAINTED TO WINDOW FRAME

DOOR:

EXTENDED WOOD JAMB W/ 1/4" REVEAL; POPLAR, PAINTED TO MATCH DOOR FRAME


MALLETTE RESIDENCE

SCHEDULES

©shift architects

SHEET NUMBER

A8.2

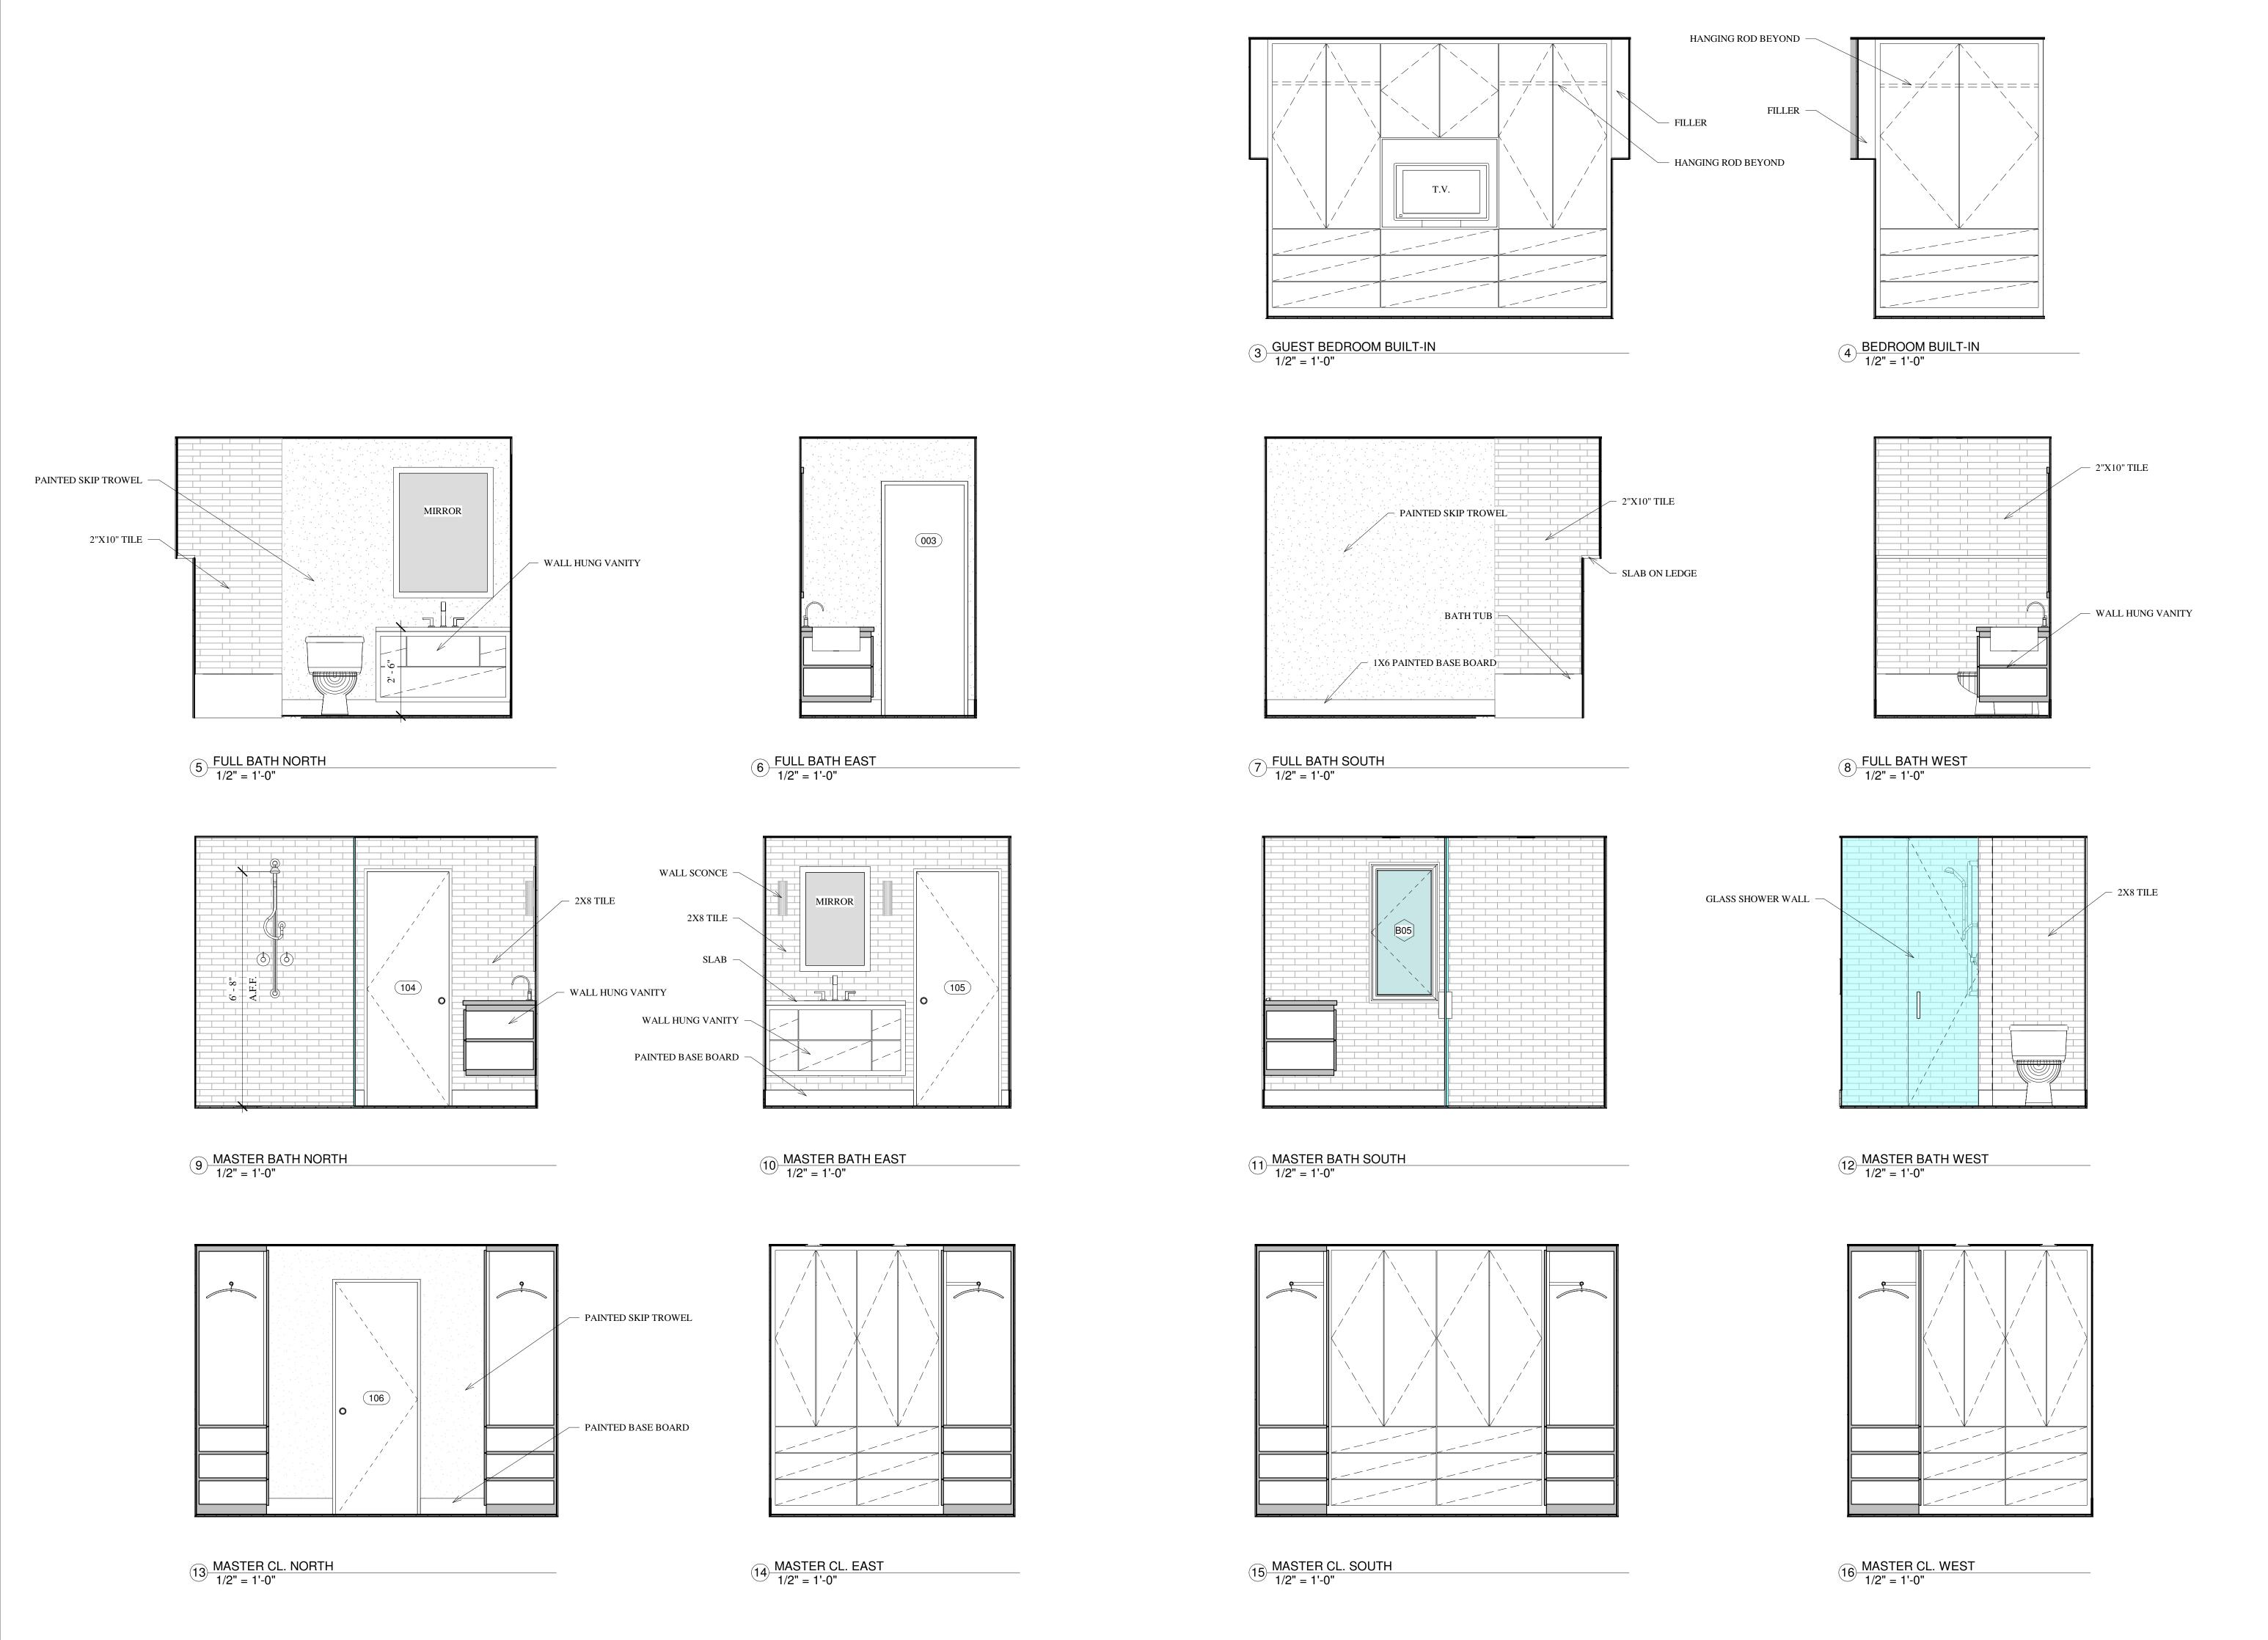

RESIDENCE

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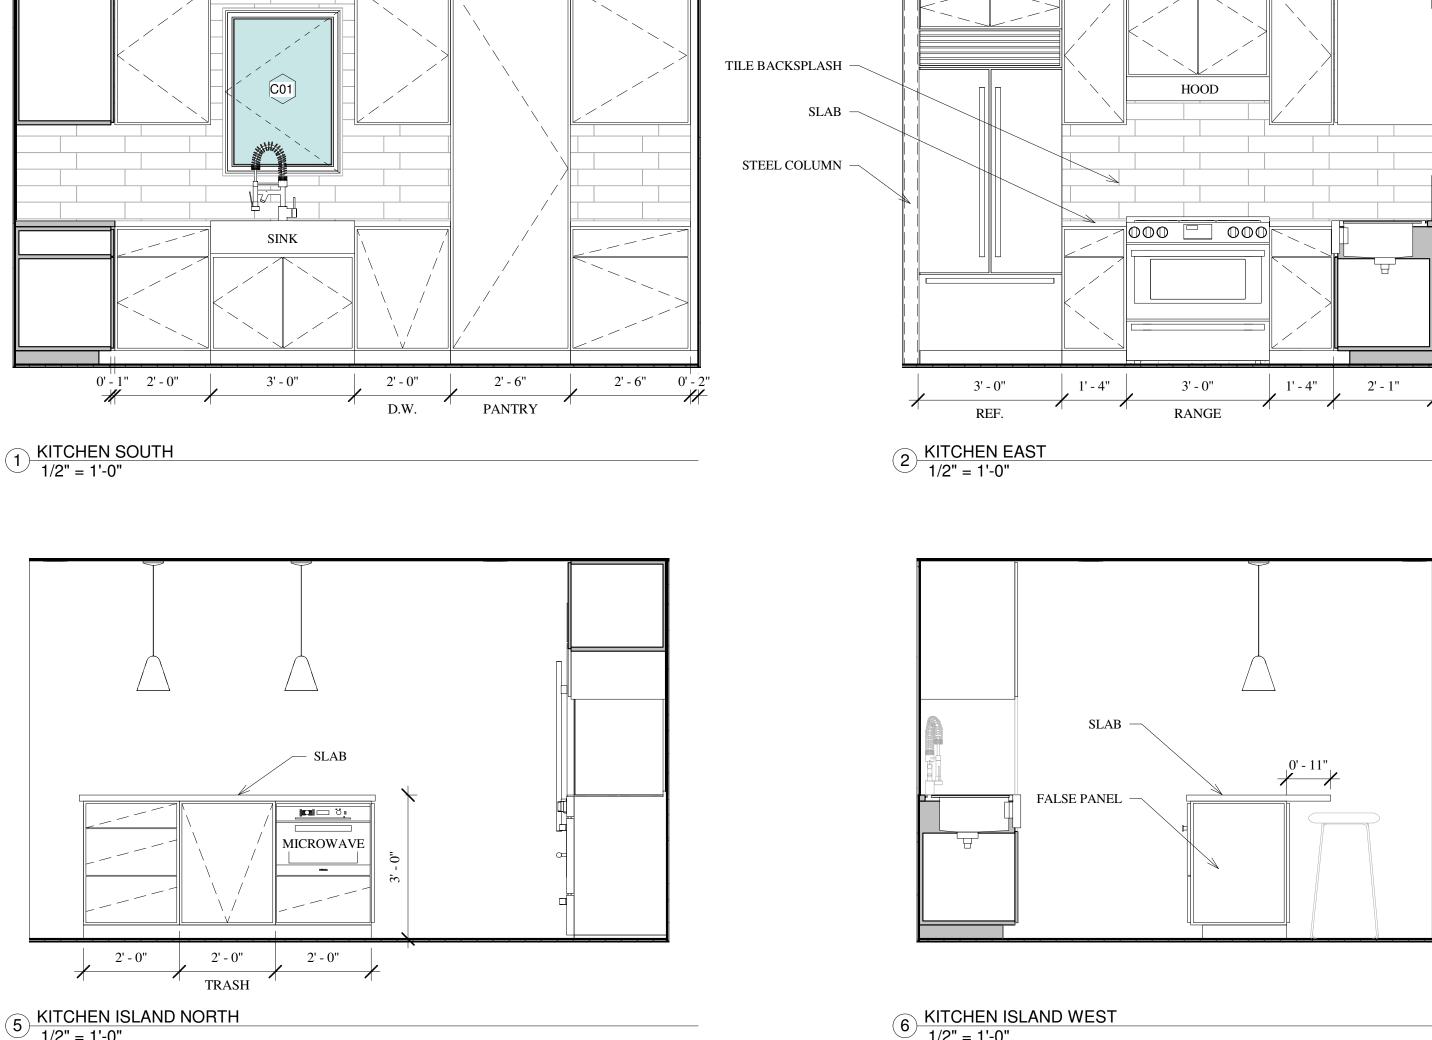
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A9-1

INTERIOR

ELEVATIONS







GAS F.P.

WINDOW SEAT —

7 FIREPLACE 1/2" = 1'-0"

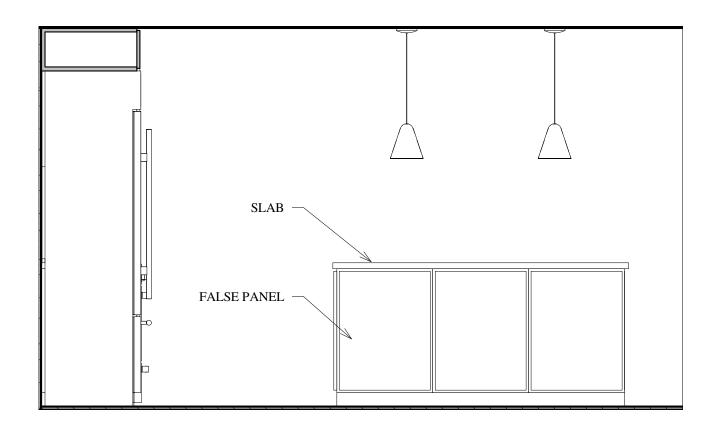

3 KITCHEN ISLAND SOUTH 1/2" = 1'-0"

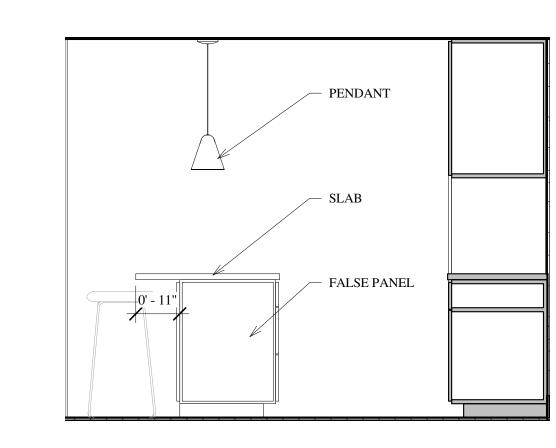

4 KITCHEN ISLAND EAST 1/2" = 1'-0"

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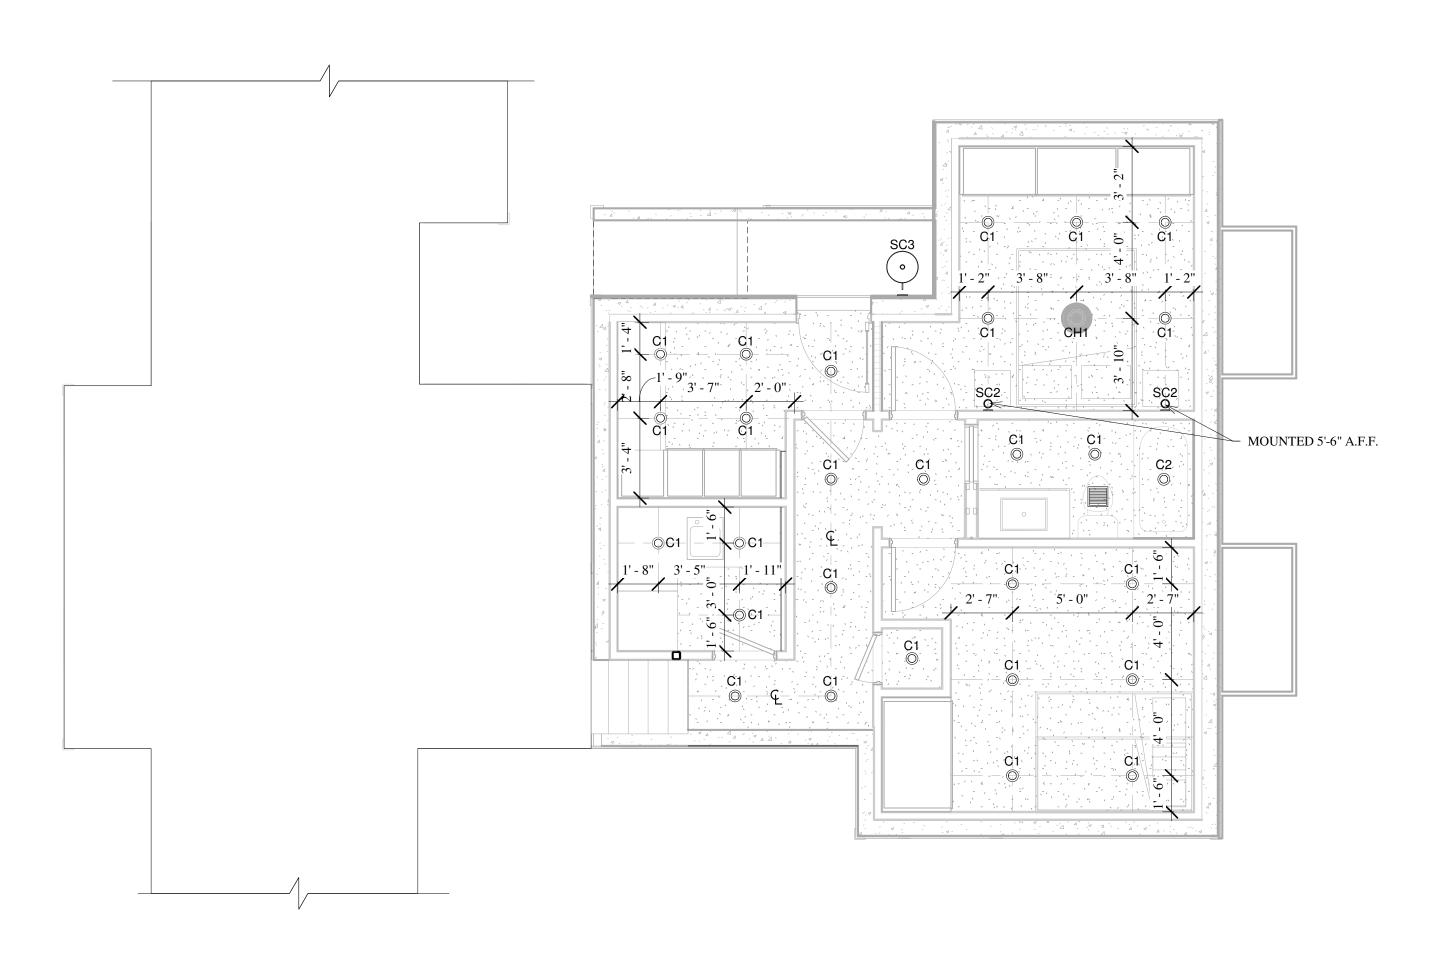
DATE:

REVISED HOA SET 07.07.22

INTERIOR ELEVATIONS

SHEET NUMBER

A9.2



1 NEW BASEMENT RCP 1/4" = 1'-0"

Grand total: 85

LIGHTING FIXTURE SCHEDULE							
Type	Type Mark	Count					
4" CAN	C1	73					
4" CAN WATER PROOF	C2	2					
CHANDELIER 1	CH1	2					
CHANDELIER	CH2	1					
PENDANT	P1	2					
WALL SCONCE	SC1	2					
WALL SCONCE 2	SC2	2					
OUTDOOR WALL SCONCE	SC3	1					

LIGHTING NOTES:

1. FIELD VERIFY ALL LIGHTING LOCATIONS.

2. TYPICAL LIGHTING LOCATION AT STAIRS: (2 EA) PER LANDING (2 EA) PER RUN

3. CONTRACTOR SHALL TAKE CARE IN PLANNING ROUGH FRAMING LAYOUT AS IT RELATES TO THE NEED TO CENTER FIXTURES IN HALLWAYS, RECESSES AND OTHER AREAS WHERE RELATIONSHIPS DON'T OFFER ANY LATITUDE OR FIELD ADJUSTMENTS.

4. ALL RECESSED FIXTURES AT INSULATED CEILINGS TO BE IC RATED AND CERTIFIED AIR TIGHT CONSTRUCTION. ALL EXTERIOR FIXTURES, SHOWER FIXTURES AND FIXTURES OVER TUBS TO BE MARKED "SUITABLE FOR DAMP LOCATIONS".

5. ALL INTERIOR WALL SCONCES TO BE MOUNTED 5'-6" A.F.F. U.O.N.


© 4" RECESSED CAN

(°) PENDANT

CHANDELIER


WALL SCONCE

BATHROOM EXHAUST FAN

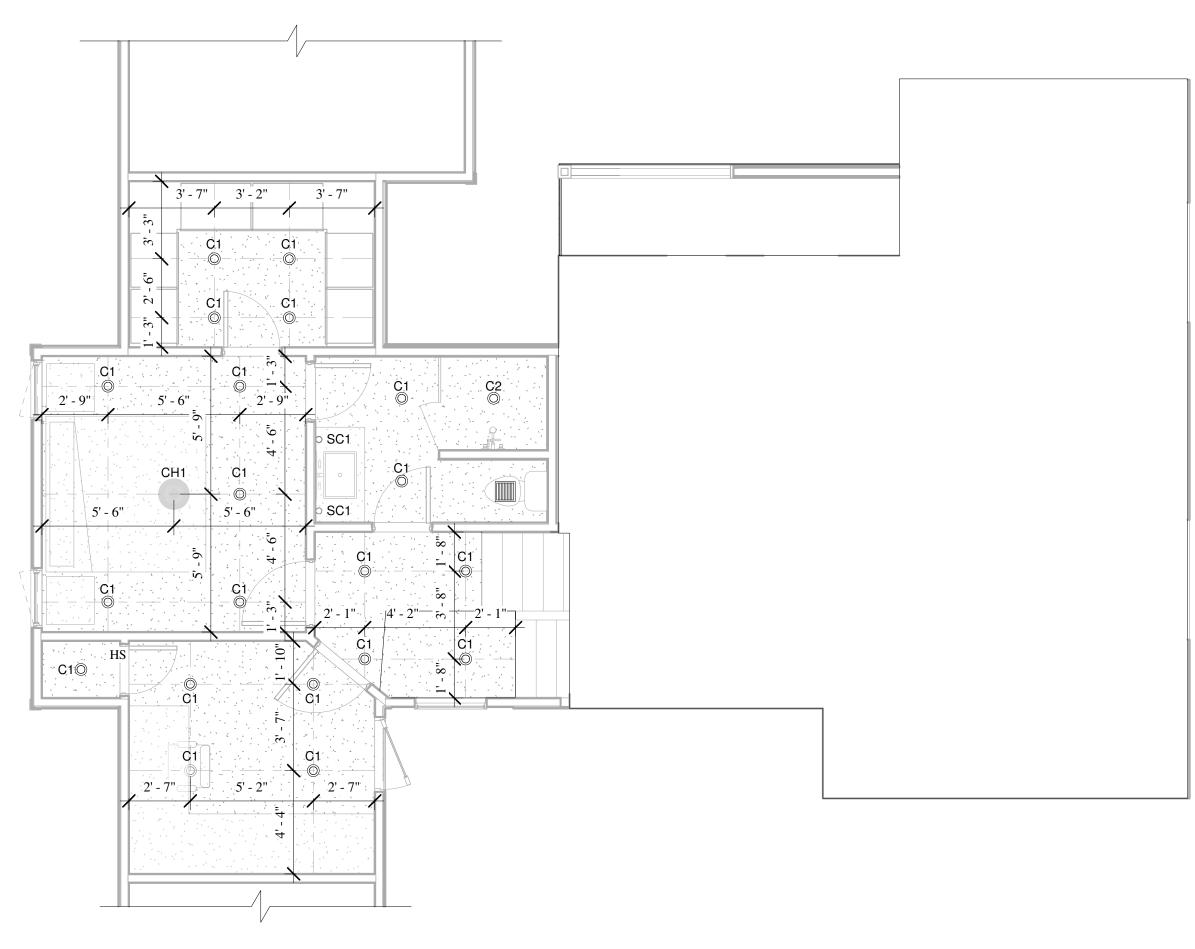

2 LOWER LEVEL RCP 1/4" = 1'-0"

3 MAIN LEVEL RCP 1/4" = 1'-0"

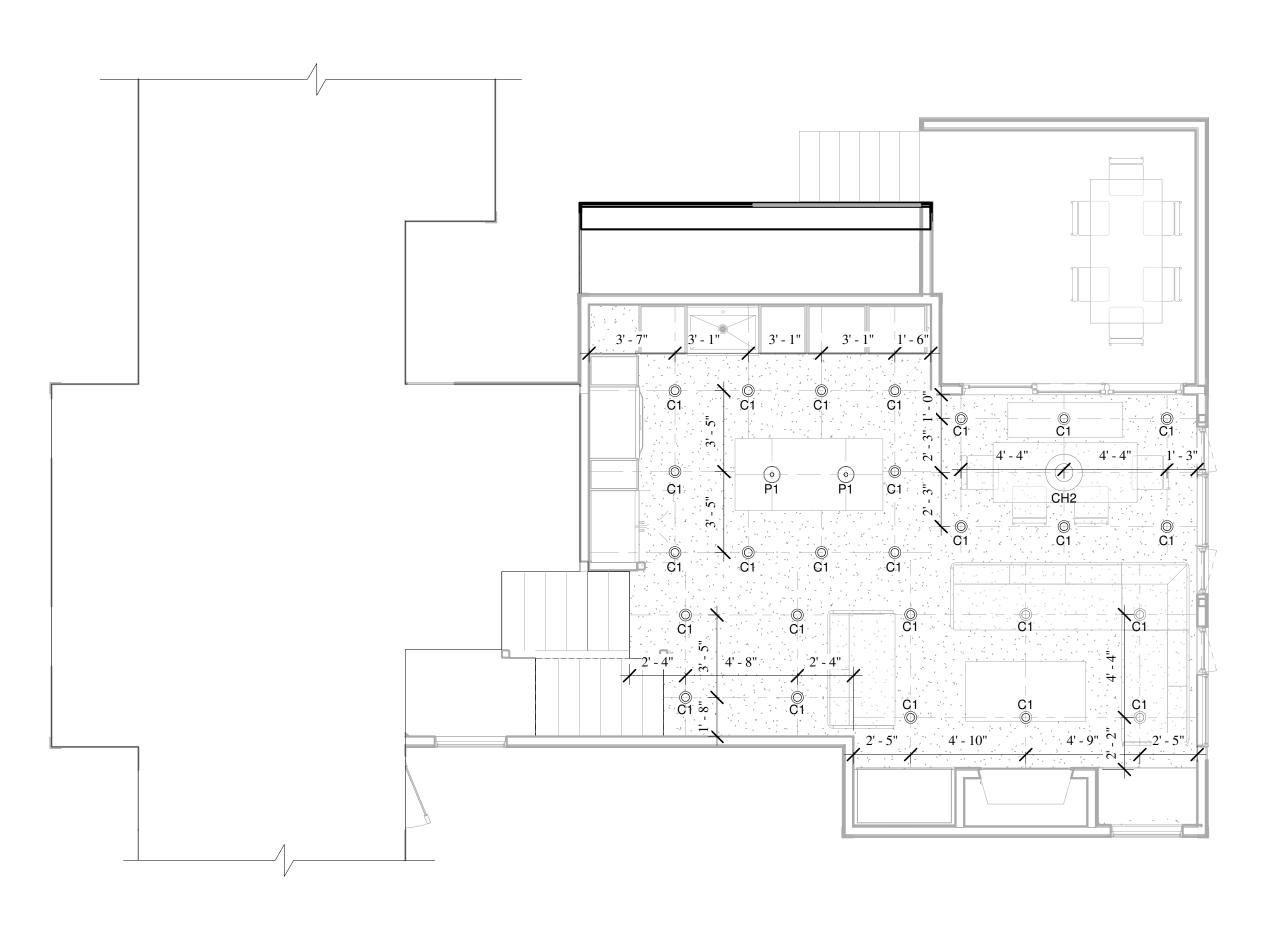

SHIFT

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ALLETTE RESIDENCE

LIGHTING PLANS

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SHEET NUMBER

Se:49 PM LTG1.1

DESIGN CRITERIA:

BUILDING CODES: 2009 INTERNATIONAL RESIDENTIAL CODE (IRC) AMERICAN CONCRETE INSTITUTE (ACI) 301, 318 CONCRETE REINFORCING STEEL INSTITUTE (CRSI) AMERICAN INSTITUTE OF STEEL CONSTRUCTION (AISC) ANSI/AF&PA NDS- NATIONAL DESIGN SPECIFICATION (NDS)

DESIGN LOADS: ROOF SNOW LOAD = 75 PSF

FLOOR LIVE LOAD = 40 PSF WIND LOAD = 90 MPH (EXPOSURE B, I=1.0) SEISMIC ZONE 1 ALLOWABLE SOIL BEARING PRESSURE = 2000 PSF (PRESUMED)

GENERAL NOTES:

- These plans are intended for use by qualified personnel experienced in the type(s) of construction shown HEREIN. IT IS THE RESPONSIBILITY OF THE CONTRACTOR TO REVIEW THESE PLANS AND SPECIFICATIONS AND FULLY COORDINATE THEIR USE WITH ALL OTHER CONSTRUCTION DOCUMENTS ISSUED AS PART OF THIS PROJECT INCLUDING, BUT NOT LIMITED TO, ARCHITECTURAL, MECHANICAL AND ELECTRICAL PLANS AND SPECIFICATIONS. CONTRACTOR SHALL VERIFY THE EXISTING SITE CONDITIONS. CONTRACTOR SHALL NOTIFY THE ENGINEER OF ANY DISCREPANCIES AND/OR CONFLICTS BETWEEN THESE PLANS AND SPECIFICATIONS AND THOSE ISSUED BY OTHERS BEFORE PROCEEDING WITH CONSTRUCTION.
- 2. DIMENSIONS SHOWN ON STRUCTURAL DRAWINGS SHALL BE VERIFIED BY THE CONTRACTOR WITH THOSE SHOWN ON THE ARCHITECTURAL DRAWINGS. ANY DISCREPENCIES SHALL BE BROUGHT TO THE ATTENTION OF THE ENGINEER PRIOR TO
- CONSTRUCTION MATERIALS SHALL NOT BE PLACED, STACKED OR OTHERWISE STORED UPON ANY STRUCTURAL ELEMENT IN A MANNER WHICH EXCEEDS THE LIVE LOAD CAPACITY OF THE ELEMENT. UNLESS OTHERWISE NOTED, THIS LIVE LOAD
- 4. NOTES, DETAILS AND DIMENSIONS ON INDIVIDUAL DRAWINGS SHALL TAKE PRECEDENCE OVER GENERAL STRUCTURAL NOTES AND TYPICAL DETAILS. ANY DISCREPANCIES SHALL BE BROUGHT TO THE ENGINEERS ATTENTION BEFORE PROCEEDING WITH
- 5. THE CONTRACTOR SHALL BE SOLEY RESPONSIBLE FOR PROVIDING ALL MEASURES NECESSARY TO PROTECT THE STRUCTURE DURING ALL PHASES OF CONSTRUCTION. SUCH MEASURES SHALL INCLUDE, BUT ARE NOT NECESSARILY LIMITED TO, TEMPORARY BRACING/SHORING AGAINST WIND, SNOW, EQUIPMENT, MATERIAL STORAGE AND/OR OTHER LOADS WHICH MAY ARISE PRIOR TO THE COMPLETION OF CONSTRUCTION, PERIODIC INSPECTIONS BY THE STRUCTURAL ENGINEER SHALL NOT INCLUDE INSPECTION OF THESE ITEMS NOR ANY OPINION REGARDING THE ADEQUACY OF SUCH MEASURES.

- 1. CONCRETE SHALL COMPLY WITH THE PROVISIONS OF THE AMERICAN CONCRETE INSTITUTE (ACI) 301 "SPECIFICATIONS FOR STRUCTURAL CONCRETE FOR BUILDINGS", ACI 318 "BUILDING CODE REQUIREMENTS FOR STRUCTURAL CONCRETE". REINFORCING STEEL SHALL COMPLY WITH THE CONCRETE REINFORCING STEEL INSTITUTE (CRSI) "MANUAL OF STANDARD PRACTICE" EXCEPT WHERE MORE STRINGENT REQUIREMENTS ARE INDICATED.
- 2. CONCRETE SHALL HAVE A MINIMUM COMPRESSIVE STRENGTH OF 4000 PSI AT 28 DAYS, AND A MAXIMUM WATER-CEMENT RATIO OF 0.46, CONCRETE SHALL FORMULATED USING AIR ENTRAINING ADMIXTURES PROVIDING NOT LESS THAN 5.0 PERCENT NOR MORE THAN 7.0 PERCENT ENTRAINED AIR. AIR ENTRAINING ADMIXTURES SHALL CONFORM TO ASTM C260.
- 3. CONCRETE DESIGN MIX SHALL BE PROPORTIONED SUCH THAT CONCRETE SLUMP, AT THE POINT OF PLACEMENT, SHALL BE NO LESS THAN 1 INCH NOR MORE THAN 3 INCHES FOR REINFORCED STRUCTURAL CONCRETE, 4 INCHES FOR ALL OTHER CONCRETE, WATER SHALL NOT BE ADDED TO THE CONCRETE BEFORE PLACEMENT UNLESS PRIOR APPROVAL IS RECEIVED IN WRITING FROM THE STRUCTURAL ENGINEER.
- 4. CONCRETE SLABS ON GRADE SHALL BE PLACED OVER A VAPOR BARRIER LAPPED A MINIMUM OF SIX INCHES AND SEALED. 5. CONCRETE SHALL BE CONSOLIDATED USING VIBRATORY EQUIPMENT AND/OR HAND RODDING AND TAMPING UNTIL CONCRETE
- IS UNIFORMLY DISTRIBUTED AROUND REINFORCEMENT AND OTHER EMBEDDED ITEMS.
- CONTRACTOR SHALL PROTECT CONCRETE FROM PHYSICAL DAMAGE OR REDUCED STRENGTH DURING MIXING, PLACEMENT AND CURING, COLD WEATHER CONCRETE PLACEMENT SHALL COMPLY WITH ACI 306.
- 7. CONCRETE REINFORCEMENT SHALL BE GRADE 60 STEEL MEETING THE REQUIREMENTS OF ASTM A615 EXCEPT FOR STIRRUPS AND TIES WHICH MAY BE GRADE 40 STEEL.
- 8. REINFORCEMENT SHALL NOT BE SPLICED NOR WELDED EXCEPT AS DETAILED OR AS AUTHORIZED IN WRITING BY THE STRUCTURAL ENGINEER. LAP SPLICES SHALL BE A MINIMUM OF 40 BAR DIAMETERS UNLESS OTHERWISE NOTED ON THE DRAWINGS. HORIZONTAL REINFORCEMENT IN WALLS SHALL BE SPLICED USING CORNER BARS OF EQUAL SIZE AND SPACING
- 9. VERTICAL REINFORCEMENT SHALL BE DOWELLED INTO FOUNDATION. DOWELS SHALL TERMINATE WITH A STANDARD HOOK NOT LESS THAN SIX INCHES OR 12 BAR DIAMETERS, WHICHEVER IS GREATER.
- 10. WELDED WIRE FABRIC SHALL CONFORM TO THE REQUIREMENTS OF ASTM A185. LAP WIRE FABRIC A MINIMUM OF ONE FULL
- MESH PLUS 2 INCHES AT SIDES AND ENDS AND TIE TOGETHER. 11. PROVIDE CLEAR CONCRETE COVER OVER REINFORCEMENT AS FOLLOWS:

CONCRETE	CAST	AGAINST	AND PE	RMANENTL	Y EXPOSED	TO EARTH		3"
CONCRETE	EXPOS	SED TO E	ARTH OF	WEATHER	- #6 AND	LARGER		2
							w wf	
CONCRETE	NOT E	EXPOSED	TO WEAT	THER OR II	CONTACT	WITH GROUN	ID	1- / 2°

- 12. ANCHOR BOLTS SHALL CONFORM TO ASTM A307. EXPANSION BOLTS SHALL BE HILTI KWIK BOLTS OR APPROVED EQUIVALENT. EXPANSION BOLTS SHALL BE INSTALLED PER MANUFACTURER'S WRITTEN INSTRUCTIONS. WHERE EMBEDMENT LENGTH, EDGE DISTANCE(S) AND/OR SPACING REQUIREMENTS OF THE MANUFACTURER CANNOT BE MET, EPOXY ANCHORS
- 13. NON SHRINK GROUT SHALL BE 5000 PSI FIVE STAR GROUT OR APPROVED EQUAL, INSTALLED PER MANUFACTURER'S WRITTEN INSTRUCTIONS.
- 14. ANCHOR BOLTS FOR USE IN WOOD STUD WALL CONSTRUCTION SHALL BE 发" # WITH A MINIMUM EMBEDMENT LENGTH OF 8 INCHES, ANCHOR BOLTS SHALL BE INSTALLED AT 48" O.C. AND WITHIN 12 INCHES OF EACH END OF FOUNDATION SILL PLATES, SILL PLATES SHALL BE SECURED TO FOUNDATION WITH NUT & WASHERS, ANCHOR BOLTS USED FOR COLUMN BASE PLATES AND OTHER STEEL TO CONCRETE CONNECTIONS SHALL BE OF THE TYPE AND SIZE DETAILED ON THE PLANS, EMBEDDED A MINIMUM OF 12-INCHES INTO CAST-IN-PLACE CONCRETE. ANCHOR BOLTS SHALL PROJECT ABOVE FINISHED CONCRETE SURFACE FOR SUFFICIENT DISTANCE TO INSTALL GROUT, BASE PLATE, NUT AND WASHERS AS DETAILED LEAVING A MINIMUM OF FIVE (5) FULL THREADS EXPOSED ABOVE NUT AFTER INSTALLATION. CONTRACTOR SHALL PROTECT ANCHOR BOLTS FROM DAMAGE DURING CONSTRUCTION. ANCHOR BOLTS WHICH BECOME BENT OR OTHERWISE DAMAGED DURING CONSTRUCTION SHALL BE REMOVED AND REPLACED.
- 15. POLYSTYRENE FOAM FORMS MAY BE USED TO FORM CONCRETE WALLS ONLY IF APPROVED BY THE ENGINEER, FORMS SHALL PROVIDE FULL WIDTH OF CONCRETE AS SHOWN ON THE DRAWINGS AND SHALL BE INSTALLED PER MANUFACTURER'S WRITTEN INSTRUCTIONS INCLUDING RECOMMENDED SHORING, BRACING AND CONSOLIDATION OF CONCRETE DURING
- 16. CONCRETE SLABS ON GRADE SHALL BE 4" THICK (MIN.) WITH 6x6-W5.5xW5.5 WWF REINFORCEMENT CENTERED IN SLAB OR #3's @ 16" EA. WAY, CENTERED, OVER 6-MIL VAPOR BARRIER. SLABS WHICH ARE HYDRONICALLY HEATED SHALL BE PLACED OVER 2" RIGID INSULATION OVER 6-MIL VAPOR BARRIER OR PRODUCT APPROVED AS EQUAL BY THE ENGINEER.
- 17, CONCRETE CONSTRUCTION JOINTS, EXPANSION JOINTS AND CONTROL JOINTS SHALL BE LOCATED AS SHOWN ON THE DRAWINGS, CONTROL JOINTS WHICH ARE FORMED BY SAWING SHALL BE COMPLETED WITHIN 24 HOURS OF CONCRETE PLACEMENT AND WITHOUT DAMAGE TO CONCRETE SURFACE.

STRUCTURAL WOOD FRAMING

- 1. SAWN LUMBER USED FOR STRUCTURAL FRAMING SHALL BE HEM-FIR, NO. 2/BTR CONFORMING TO THE REQUIREMENTS OF NDS 1997, UNLESS OTHERWISE NOTED ON THE DRAWINGS.
- 2. SAWN LUMBER SIZES SHOWN ARE NOMINAL (DRESSED) DIMENSIONS UNLESS OTHERWISE NOTED.
- 3. PLYWOOD SHEATHING USED FOR HORIZONTAL (FLOOR) DIAPHRAGMS AND VERTICAL (SHEAR WALL) DIAPHRAGMS SHALL BE APA RATED STRUCTURAL GRADE 1 WHEREVER SUCH DIAPHRAGMS ARE INDICATED ON THE DRAWINGS, DIAPHRAGMS SHALL BE FULLY BLOCKED UNLESS NOTED OTHERWISE. FASTENER SIZE AND SPACING SHALL BE AS INDICATED ON THE DRAWINGS.
- 4. MICROLLAMS (ML) AND LAMINATED VENEER LUMBER (LVL) SHALL HAVE A MINIMUM ALLOWABLE BENDING STRESS (Fb) OF 2600 PSI AND A MINIMUM MODULUS OF ELASTICITY (E) OF 1,800,000 PSI.
- 5. I-JOISTS SHALL BE AS MANUFACTURED BY TRUS-JOIST CORPORATION OR APPROVED EQUAL WITH A MINIMUM FLANGE WIDTH OF $1-\frac{3}{4}$ " (SERIES 210).
- 6. SOLID BLOCKING SHALL BE INSTALLED AT EVERY FLOOR AND ROOF JOIST SUPPORT. WEB STIFFENERS FOR I-JOISTS SHALL BE INSTALLED AT ALL LOCATIONS REQUIRED BY THE JOIST MANUFACTURER. STUD WALLS SHALL BE BLOCKED EVERY 48 INCHES (VERTICAL) UNLESS OTHERWISE NOTED ON THE DRAWINGS.
- 7. PREFABRICATED STEEL CONNECTIONS SHALL BE SIMPSON STRONG TIE OR APPROVED EQUAL. CONNECTORS SHALL BE INSTALLED IN ACCORDANCE WITH MANUFACTURER'S WRITTEN INSTRUCTIONS USING THE TYPE, SIZE AND NUMBER OF FASTENERS SPECIFIED FOR EACH CONNECTOR.
- 8. STRUCTURAL FRAMING MEMBERS SHALL NOT BE NOTCHED, DRILLED OR OTHERWISE ALTERED BEYOND WHAT IS SPECIFICALLY PERMITTED BY THE PRODUCT MANUFACTURER WITHOUT WRITTEN PERMISSION OF THE STRUCTURAL ENGINEER.
- 9. MECHANICALLY LAMINATED (BUILT-UP) COLUMNS SHALL BE FASTENED IN ACCORDANCE WITH NDS 15.3.1. BUILT UP COLUMNS COMPRISED OF 4 OR MORE PLYS SHALL BE BOLTED. MULTIPLE LVL PLYS SHALL BE CONNECTED PER MANUFACTURER'S WRITTEN INSTRUCTIONS.

STRUCTURAL STEEL


- 1. STRUCTURAL STEEL SHALL CONFORM TO ASTM A36 UNLESS OTHERWISE NOTED ON THE DRAWINGS. TUBE STEEL SHALL CONFORM TO ASTM A500 AND PIPE STEEL SHALL CONFORM TO ASTM A53, GRADE B. BOLTS USED FOR STEEL CONNECTIONS SHALL BE ASTM A325 UNLESS OTHERWISE NOTED.
- 2. ALL WELDING SHALL BE PERFORMED BY AWS CERTIFED WELDERS EXPERIENCED IN THE TYPE OF WELD(S) SPECIFIED ON THE DRAWINGS. WELDS SHALL BE PERFORMED USING E70XX ELECTRODES IN ACCORDANCE WITH THE LATEST AWS STANDARDS.
- 3. STRUCTURAL STEEL SHALL BE FABRICATED AND ERECTED IN ACCORDANCE WITH THE AISC MANUAL OF STEEL CONSTRUCTION AND AISC CODE OF STANDARD PRACTICE.
- 4. SHOP DRAWINGS DETAILING EACH MEMBER AND THEIR CONNECTIONS SHALL BE SUBMITTED TO THE STRUCTURAL ENGINEER PRIOR TO FABRICATION. STEEL SHALL BE SHOP PRIMED.


SUBMITTALS


- CONTRACTOR SHALL SUBMIT ALL QUESTIONS REGARDING THESE PLANS IN A WRITTEN REQUEST FOR INFORMATION (RFI).
- CONTRACTOR SHALL SUBMIT REQUEST FOR ANY MATERIAL SUBSTITUTION IN WRITING FOR ENGINEER'S APPROVAL.


ABBREVIATIONS:


AB	ANCHOR BOLT	HAS	HEADED ANCHOR STUD
BOW	BOTTOM OF WALL	IF	INSIDE FACE
BRG	BEARING	INT	INTERIOR
₽.	CENTERLINE	OF	OUTSIDE FACE
CONT	CONTINUOUS	PT	PRESSURE TREATED
CTL	CONTROL	PL	PLATE
CTR	CENTER	SCHED	SCHEDULE
D-FIR	DOUGLAS FIR	T&B	TOP AND BOTTOM
EF	EACH FACE	TOBM	TOP OF BEAM
EL	ELEVATION	TOF	TOP OF FOOTING
EW	EACH WAY	TOW	TOP OF WALL
EXT	EXTERIOR	TRANS	TRANSVERSE
FF	FINISHED FLOOR	TYP	TYPICAL
FTG	FOOTING	UNO	UNLESS NOTED OTHERWISE

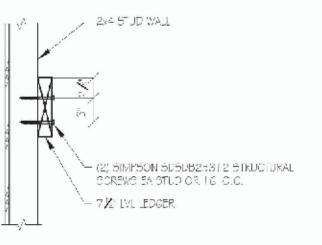


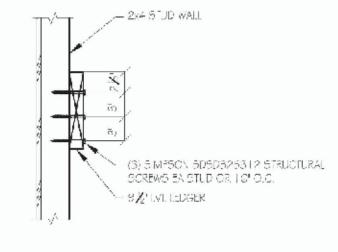

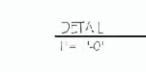

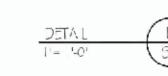


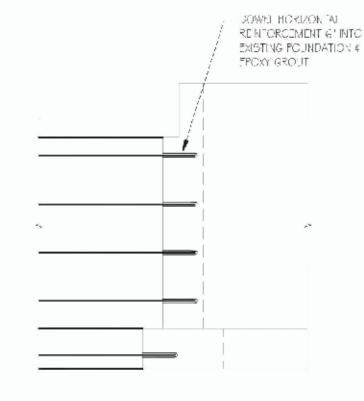

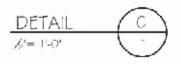




PERMIT SET 06.23.22

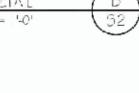


STRUCTURAL **NOTES**






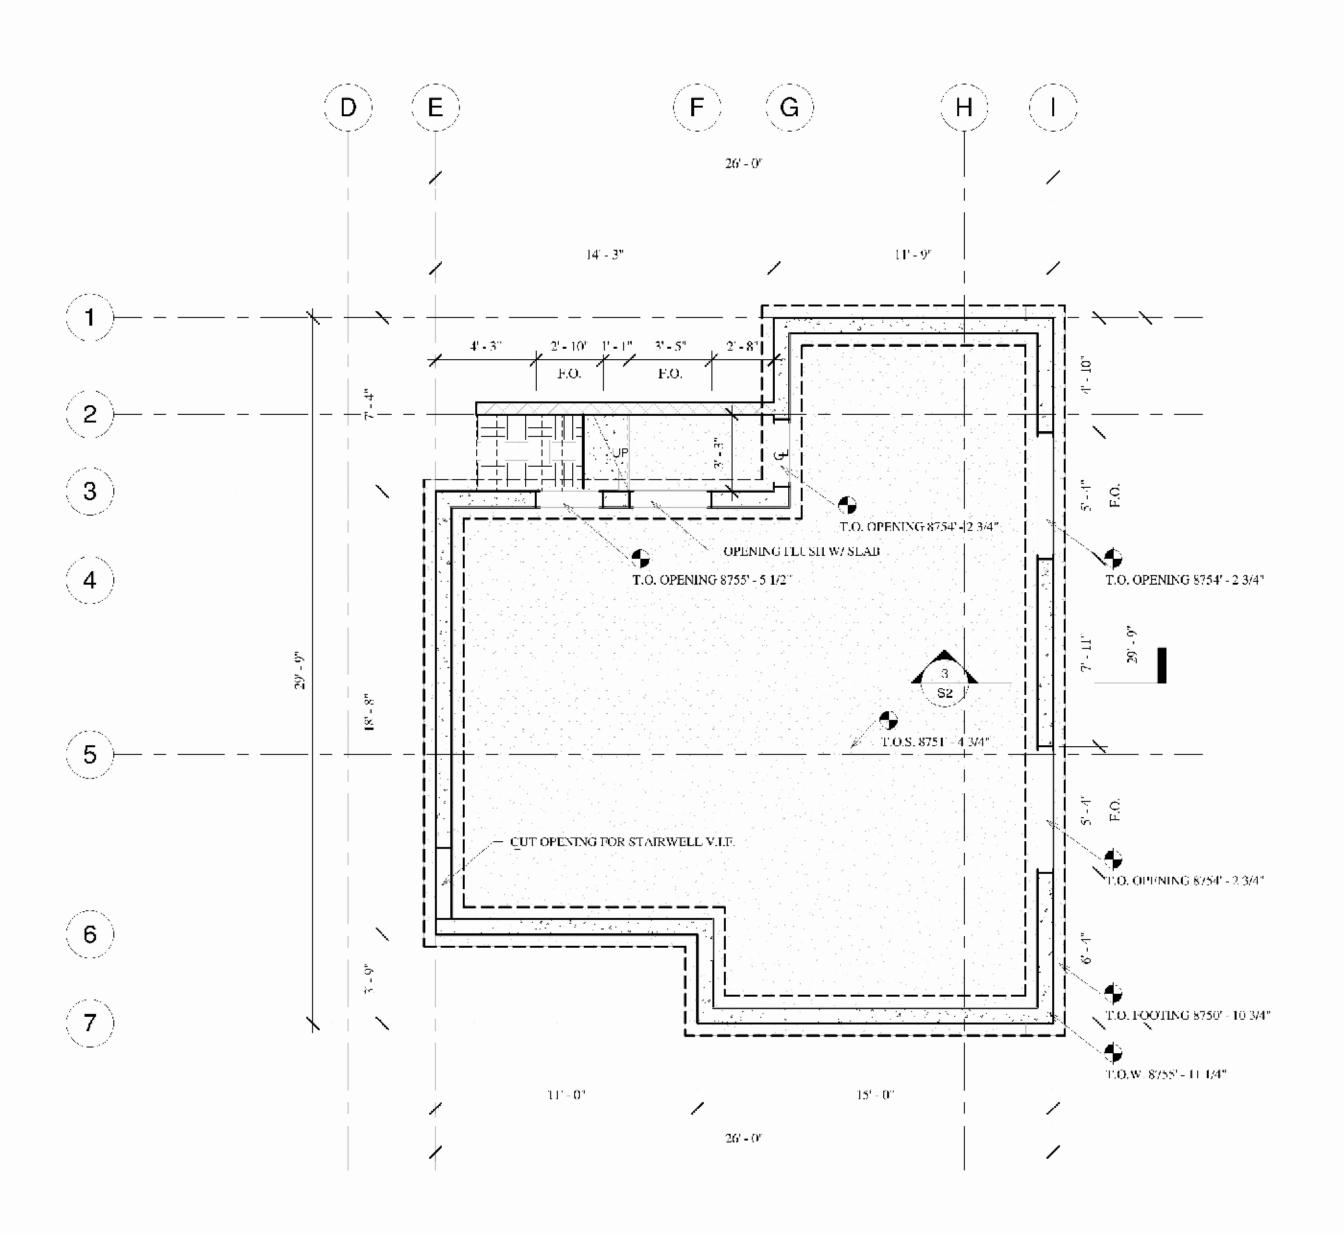


(1) FOUNDATION PLAN 1/4" = 1'-0"

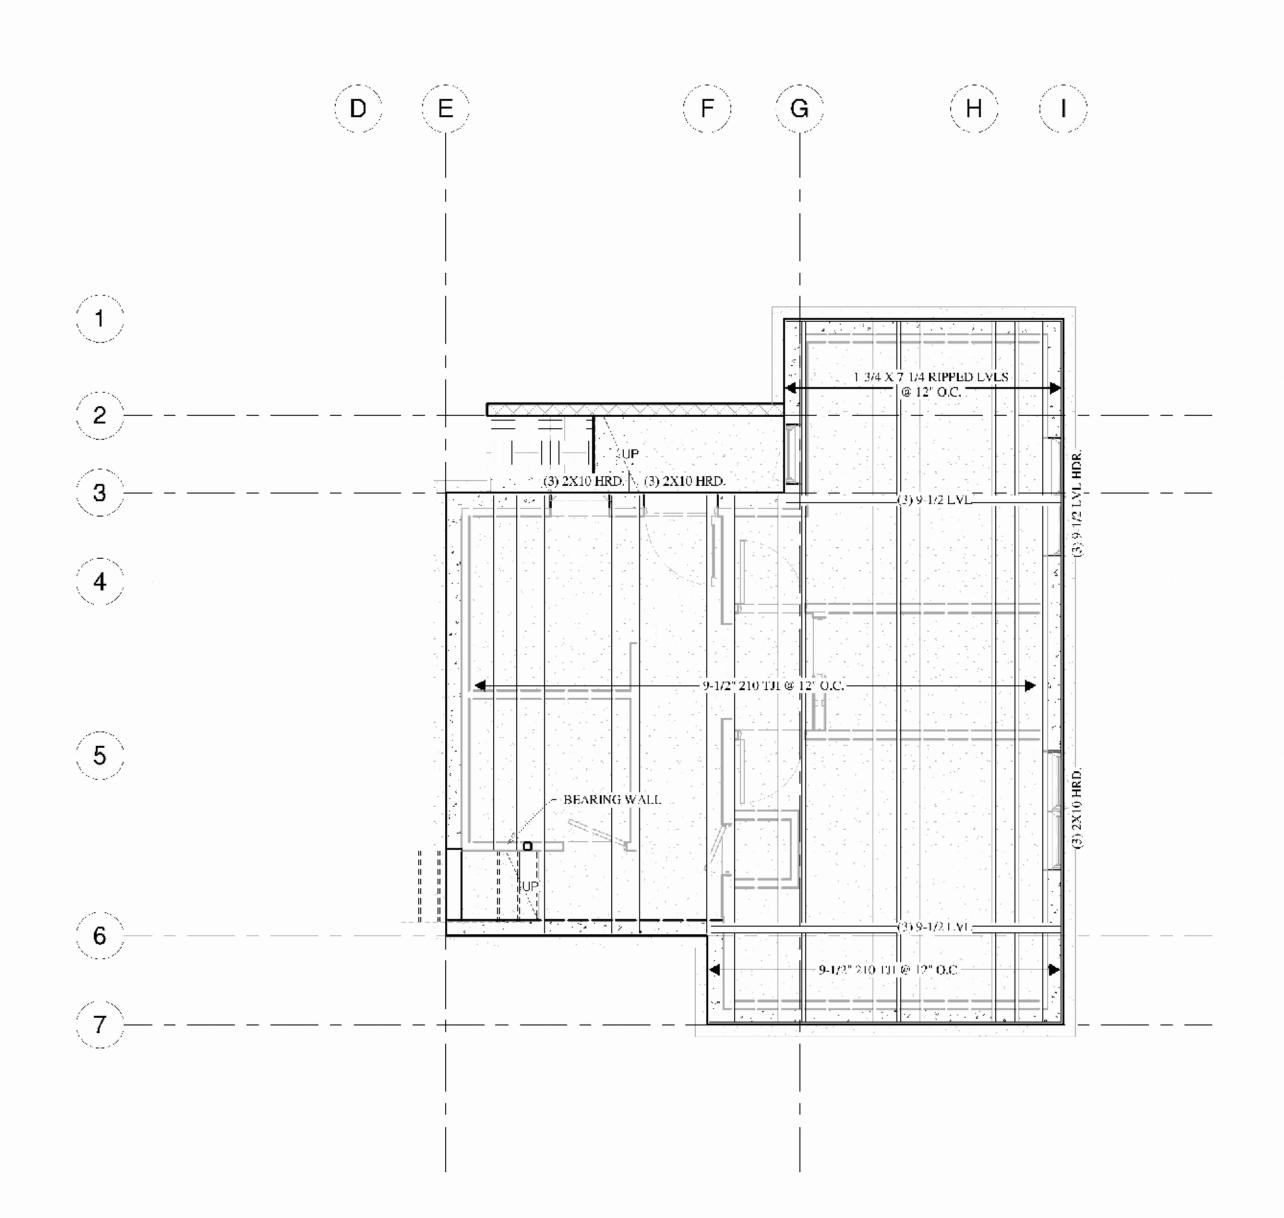

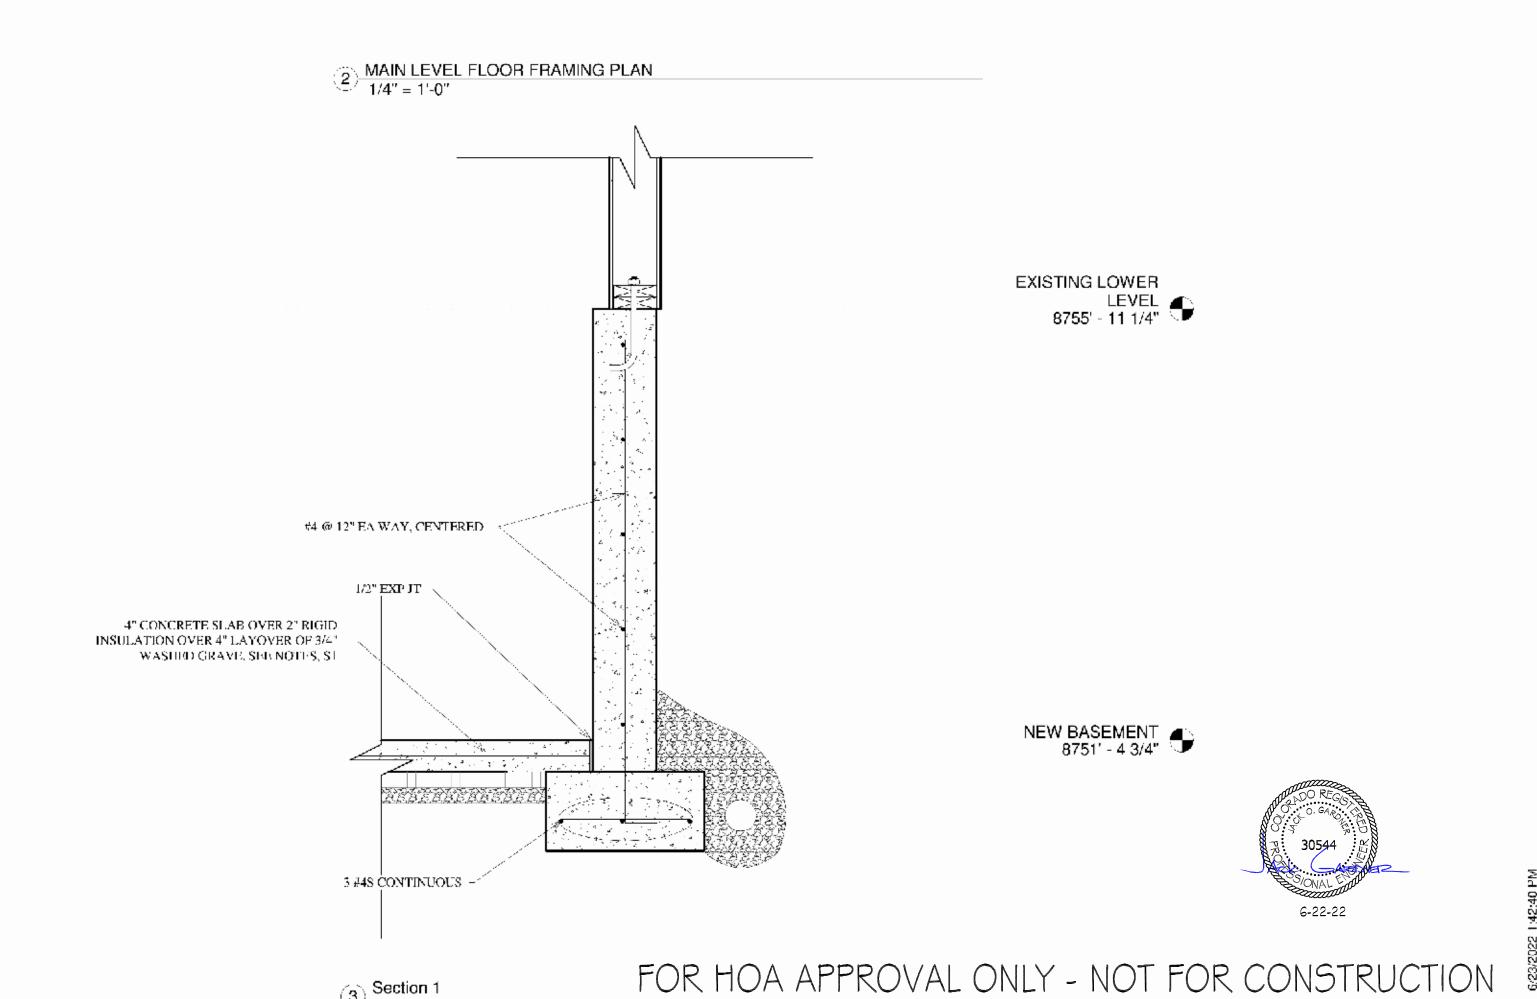

(3) Section 1 1" = 1'-0"

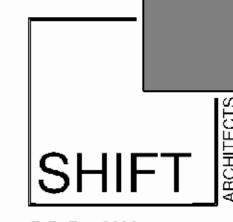

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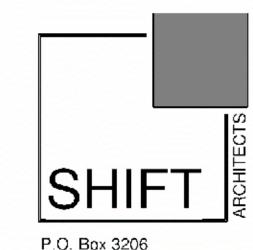
DATE:

PEHMIT SET 06.23.22

FLOOR FRAMING **PLANS**

SHEET NUMBER

S2



DATE:

 $\begin{pmatrix}
\mathbf{H}
\end{pmatrix}$

PERMIT SET 06.23.22

2 MAIN LEVEL FRAMING PLAN
1/4" = 1'-0"

(C) (D) (E)

EX. F.J.

BEARING WALL

- HSS 4X4X3/8 COLUMN

(G)

(H)

(B)

1) LOWER LEVEL FRAMING PLAN 1/4" = 1'-0"

(3)

<u>(5)</u>—

(6)

7

(F)


LLETTE

747 W PAC TELLURIDE

FLOOR FRAMING PLANS

<u>:</u>

SHEET NUMBER

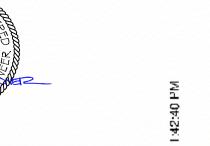

S3